

City of Belle Isle Job Site Card Electrical PERMIT 2019-07-068

PERMIT MUST BE POSTED ON SITE - A permit expires in 6 months if approved inspections are not recorded /scheduled within that time frame. You are responsible for scheduling and keeping track of all your inspections -

Site Address: 3042 Hoffner Ave 32812 **Parcel #:** 19-23-30-4382-02-380

Class: □ Residential **Subdivision**:

Description of Work: Electrical - ADDING SOLAR ELECTRIC PANELS TO HOME - PHOTO - VOLTAIC

Issued:	SUNLIGHT S	OLAR	Business Phone: 321 886-3388	
Name:	SCARLATO, A		Contractor License: EC13008138	
Paymen	it Date & Method	: 8	/ / 2019 Picked up or sent by Goria Page = Emailed	
□ Visa	□ Master Card		Discover Check / Money Order # 68 48	

Schedule Inspections via Email at: <u>BIDscheduling@universalengineering.com</u> BY 3:00 PM CUT OFF TIME Inspection Results Will Be Sent Out the Following Business Day

"WARNING TO OWNER: YOUR FAILURE TO RECORD A NOTICE OF COMMENCEMENT MAY RESULT IN YOUR PAYING TWICE FOR IMPROVEMENTS TO YOUR PROPERTY. IYOU INTEND TO OBTAIN FINANCING, CONSULT WITH YOUR LENDER OR AN ATTORNEY BEFORE RECORDING YOUR NOTICE OF COMMENCEMENT."

ELECTRICAL	INSPECTOR	DATE	COMMENTS
300 Temp Pole			
310 TUG			
320 Underground			
330 Rough			
340 Footer Steel			
Bonding			
350 Pool Light			
360 PrePower			
370 Meter ReSet			
380 Final			

Inspection requests are to be emailed to BIDscheduling@UniversalEngineering.com; a confirmation email will be sent back to you upon scheduling. Next-Day Inspection requests must be made by 3pm. Please include the following in your request: Permit #, project address, type of inspection, date of the requested inspection, a contact name & a contact phone number. AM or PM may be requested but cannot be guaranteed. Universal Engineering Sciences - 3532 Maggie Blvd., Orlando, FL 32811 Tel 407-581-8161 Fax 407-581-0313 www.universalengineering.com



City of Belle Isle
Universal Engineering Sciences 3532 Maggie Blvd., Orlando, FL 328
Tel 407-581-8161 * Fax 407-581-0313 * www.universalengineering

APPLICATION FOR ELECTRICAL PERMIT

WARNING TO OWNER: YOUR FAILURE TO RECORD A NOTICE OF COMMENCEMENT MAY RESULT IN YOUR PAYING TWICE FOR IMPROVEMENTS TO YOUR PROPERTY. A NOTICE OF COMMENCEMENT MUST BE RECORDED AND POSTED ON THE JOB SITE BEFORE THE FIRST INSPECTION. IF YOU INTEND TO OBTAIN FINANCING, CONSULT WITH YOUR LENDER OR AN ATTORNEY BEFORE RECORDING YOUR NOTICE OF COMMENCEMENT.

	1.23-19		2010-02-6	10/
DATE OF APPLICATION:			MBER 2019-01-6	68
The undersigned hereby applies	s for a permit to make electrica	al installations as indicated below	. PLEASE PRINT	
Project Address 3042 Hoffner Avenu	3/1124	a Cinar AIM		
Project Address 3042 Hoffner Avenu	ie Orlando, FL 0090 []	Be	lle Isle FL3280932812	
Property Owner David & Christine W	loods In Donal S D	Carl al		
Property Owner David & Clinistille VV	Joods VOODOLJ, J	Ph	one 407 340 8373	=3
Property Owner's Mailing Addres	ss 3042 Hoffner Avenue	Cit	y_Orlando	
Troporty Owner's Maining Addres	55	CII	y_onanao	—0:
State FL Zip Code 3	Parcel Id N	lumber: 19-23-30-4382-02-380		
			vv.ocpafl.org/Searches/ParcelSearch.aspx	<u></u> ∕-
Class of Building: Old Mev	v ☐ Type of Buildin	g: Residentia Commercial	Other	
Type of Work: New Altera	ation 🔲 Addition 🔲	Repair Low Voltage	New Existing	
				-
		OF ALL EQUIPMENT TO BE IN	STALLED	16-16 27
Dishwasher Exha	aust Fan	Disposal	Water Heater	_ ISTIC 3
		Paddle Fan		- 20 - 195
		_ Pool		- 3625
Electric Signs Mete		Low Voltage		- 2375
PumpsIvioto	ors	_Air Conditioning (tons)	Furnace (KVV)	200
Tomporary Construction Bolo	One /4	Nov. Blates Comics	Amperage/Voltage/Phas	116
remporary construction Fole	One (1) New Meter Service	Amperage/voltage/Phas	e
Meter Service Upgrade from		to	3	
	Amperage/Voltage/Phase	Amperage/Voltage/Phase	Difference in Size	3/14
,	por ago, r a languar, mass	/ importago/ voltago// riade	Billerence III Gize	010
Relocate Existing Meter Service	(No Service Size Change)			1
-		11111	/	
Other: Adding solar electric panels to	home TWOID	- VOLTALC	AGD.	7H 10110
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(IF NO METER SERVICE W	ORK BEING DONE, USE VA	LUATION OF JOB FOR PERMIT	ALLED \$ 39,235	
(IF NO METER SERVICE W	ORK BEING DONE, USE VA	LUATION OF JOB FOR PERMIT	FEE)	
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29-57-068

AFTER RECORDING - RETURN TO: Sunlight Enterprises, Inc 4854 Distribution Ct. Ste 14 Urlando, FL 32822 PERMIT NUMBER:

DOC# 20190452388 07/23/2019 11:55:35 AM Page 1 of 1 Rec Fee: \$10.00 Phil Diamond, Comptroller Orange Countý, FL IP – Ret To: SUNLIGHT ENTERPRISES INC



NOTICE OF COMMENCEMENT

The undersigned hereby gives notice that improvement will be made to certain real property, and in accordance with Chapter 713, Florida Statutes, the following information is provided in this Notice of Commencement. 1. DESCRIPTION OF PROPERTY (Legal description of the property & street address, if available) TAX FOLIO NO.: 19-23-30-4382-02-380 SUBDIVISION Lake Conway Estates BLOCK TRACT Lake Conway 2. GENERAL DESCRIPTION OF IMPROVEMENT: Adding Solar electric pa home panels J. OWNER INFORMATION OR LESSEE INFORMATION IF THE LESSEE CONTRACTED FOR THE IMPROVEMENT: 3042 Hoffner Ave. Belle Isle, FL 32812 a Name and address: David + Christine Woods b Interest in property: Home Owner c. Name and address of fee simple titleholder (if different from Owner listed above): 4. a. CONTRACTOR'S NAME: Sunlight Enterprises, Inc Contractor's address: 4854 Distribution Court Suite 14 Orlando, FL 3286, Phone number: 321-888-3388 5. SURETY (if applicable, a copy of the payment bond is attached): a. Name and address: b. Phone number: 6. B. LENDER'S NAME: 7. Persons within the State of Florida designated by Owner upon whom notices or other documents may be served as provided by Section 713.13 (1) (a) 7., Florida Statutes: a. Name and address: b. Phone numbers of designated persons: 8. a. In addition to himself or herself, Owner designates ______of _ to receive a copy of the Lienor's Notice as provided in Section 713.13 (1) (b), Florida Statutes. b. Phone number of person or entity designated by Owner, 9. Expiration date of notice of commencement (the expiration date will be 1 year from the date of recording unless a different date is WARNING TO OWNER. ANY PAYMENTS MADE BY THE OWNER AFTER THE EXPIRATION OF THE NOTICE OF COMMENCEMENT ARE CONSIDERED IMPROPER PAYMENTS UNDER CHAPTER 713, PART I, SECTION 713.13, FLORIDA STATUTES, AND CAN RESULT IN YOUR PAYING TWICE FOR IMPROVEMENTS TO YOUR PROPERTY. A NOTICE OF COMMENCEMENT MUST BE RECORDED AND POSTED ON THE JOB SITE BEFORE THE FIRST INSPECTION. IF YOU INTEND TO OBTAIN FINANCING, CONSULT WITH YOUR LENDER OR AN ATTORNEY BEFORE COMMENCING WORK OR RECORDING YOUR NOTICE OF COMMENCEMENT. Home Owner (Signature of Owner or Lessee, or Owner's or Lessee's (Print Name and Provide Signatory's Title/Office) Authorized Officer/Director/Partner/Manager) FL State of Orange County of _ 15 day of July The foregoing instrument was acknowledged before me this ___ Woods (name of person) (type of authority, ... e.g. officer, trustee, attorney in fact) (name of party on behalf of whom instrument was executed) VINICIUS S ANSELMO MY COMMISSION # GG023717 (Signature of Notary Public)

EXPIRES August 23, 2020

(Print, Type, or Stamp Commissioned Name of Notary Public)

State of FLORIDA, County of ORANGE I hereby certify that this is a true copy of the document as reflected in the Official Records PHIL DIAMOND COUNTY COMPTROLLER

DATED:



Rev. 10-15-12

LIMITED POWER OF ATTORNEY

I hereby name and appoint Gloria Pagan to be my lawful attorney in fact to act for me and


Date: 07/15/19

apply for	r a permit fo	r work to	be performed at t	he location described	as:
3042	Hoffner	Ave.	Orlando, FL	32812	
			(Address	s of Job)	
	And to sig	gn in my	name and do all th	ings necessary/to obta	ain this permit.
Aldo	Scarlato		Mus	MIN	EC13008138
			(Signature of Cert	tified Contractor)	
		((Contractor License	Number included)	
C					

County of Orange State of Florida

The foregoing instrument was	acknowledged before me this day of	July	9 _ 201 8 ,
By Aldo Scarlato who is pe	ersonally known to me, or has <u>*</u> produced		
FC DL	as type of identification		
NAMA	(SEAL)		

Signature of notary public, State of Florida

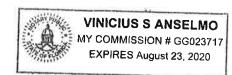

Data Contained In Search Results Is Current As Of 07/23/2019 01:47 PM.

Search Results

Please see our glossary of terms for an explanation of the license status shown in these search results.

For additional information, including any complaints or discipline, click on the name.

License Type	Name		Name Type	License Number/ Rank	Status/Expires
Certified Electrical Contractor	SCARLATO, AL	.DO	Primary	EC13008138 Cert Electrical	Current, Active 08/31/2020
License L Main Add	ocation Address*: ress*:			, UNIT 14 ORLANDO, FL ORLANDO, FL 32812	32822
Certified Electrical Contractor	SUNLIGHT SOI	LAR	DBA	EC13008138 Cert Electrical	Current, Active 08/31/2020
License Lo Main Addi	ocation Address*: ress*:			, UNIT 14 ORLANDO, FL ORLANDO, FL 32812	32822

Back



* denotes

Main Address - This address is the Primary Address on file.

Mailing Address - This is the address where the mail associated with a particular license will be sent (if different from the Main or License Location addresses).

License Location Address - This is the address where the place of business is physically located.

2601 Blair Stone Road, Tallahassee FL 32399 :: Email: Customer Contact Center: :: Customer Contact Center: 850.487.1395

The State of Florida is an AA/EEO employer. Copyright 2007-2010 State of Florida. Privacy Statement

Under Florida law, email addresses are public records. If you do not want your email address released in response to a public-records request, do not send electronic mail to this entity. Instead, contact the office by phone or by traditional mail. If you have any questions, please contact 850.487.1395. *Pursuant to Section 455.275(1), Florida Statutes, effective October 1, 2012, licensees licensed under Chapter 455, F.S. must provide the Department with an email address if they have one. The emails provided may be used for official communication with the licensee. However email addresses are public record. If you do not wish to supply a personal address, please provide the Department with an email address which can be made available to the public.

Orange County, Florida local Business. Tax Receipt is in addition to and not in lieu of any other tax required by law or municipal ordinance. Businesses are subject to regulation of zoning, health and other law of receipt year. Delinquent penalty is added October 1. Local Business Tax Receipt x Collector Scott Randolph

230 00 2018 SOLAR PAMEL INSTALLS 200

9/30/2019 EXPIRES

1 EMPLOYEE 3100-0592061

> 2 EMPLOYEES 5000 BUSINESS OFFICE SCOTT PLANTING PRATICE

230 00

TOTAL TAX PREVIOUSLY PAID TOTAL DUE

80 00 00

4626 ETHANS GLENN AVE (MOBILE) U. ORLANDO 32812 CVC56975

PA.D \$60.00 (Multiple) 2502-04365168 10/1/2018

ANSELMO PEDRO LUIZ PRESIDENT COLLECTOR .

4854 DISTRIBUTION CT STE 14 SUNLIGHT ENTERPRISES INC ORLANDO FL 32822-4922 OHAN, PLOUSE COUNTY, PLOUSE

This receipt is official when validated by the Tax Collector.

SSTUART



CERTIFICATE OF LIABILITY INSURANCE

7/15/2019

THIS CERTIFICATE IS ISSUED AS A MATTER OF INFORMATION ONLY AND CONFERS NO RIGHTS UPON THE CERTIFICATE HOLDER. THIS CERTIFICATE DOES NOT AFFIRMATIVELY OR NEGATIVELY AMEND, EXTEND OR ALTER THE COVERAGE AFFORDED BY THE POLICIES BELOW. THIS CERTIFICATE OF INSURANCE DOES NOT CONSTITUTE A CONTRACT BETWEEN THE ISSUING INSURER(S), AUTHORIZED REPRESENTATIVE OR PRODUCER, AND THE CERTIFICATE HOLDER.

IMPORTANT: If the certificate holder is an ADDITIONAL INSURED, the policy(ies) must have ADDITIONAL INSURED provisions or be endorsed. If SUBROGATION IS WAIVED, subject to the terms and conditions of the policy, certain policies may require an endorsement. A statement on this certificate does not confer rights to the certificate holder in lieu of such endorsement(s).

t	his certificate does not confer rights	to the cert	ificate holder in lieu of s	uch en	dorsement(s).	require an end	Orsenier	IL A	statement on
	DDUCER			CONT						
INS 242	SURICA Express O Springer Dr. Suite 105			PHONE (A/C, No, Ext): (405) 310-1583 FAX (A/C, No): (405) 556-2332					556-2332	
	rman, OK 73069			E-MAII ADDRI	ss: service@	DINSURICA	express.com			
					INS	SURER(S) AFFOR	RDING COVERAGE			NAIC #
				INSUR	ERA: U.S. Sp	ecialty Insi	urance Compa	iny		29599
INS	URED			INSUR	ER B:					
	Sunlight Enterprises, Inc			INSUR	ER C :					
	4854 Distribution Court 14			INSUR	ER D :					
	Oriando, FL 32822			INSUR	ER E :					
				INSUR	ERF:					
			NUMBER:				REVISION NUM			
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INSF LTR	TYPE OF INSURANCE	ADDL SUBR	POLICY NUMBER		POLICY EFF (MM/DD/YYYY)	POLICY EXP (MM/DD/YYYY)		LIMIT	's	
Α	X COMMERCIAL GENERAL LIABILITY						EACH OCCURRENCE		\$	1,000,000
	CLAIMS-MADE X OCCUR		U19AC110519-00		1/25/2019	1/25/2020	DAMAGE TO RENT PREMISES (Ea occi		s	100,000
							MED EXP (Any one		s	5,000
							PERSONAL & ADV	- 155	\$	1,000,000
	GEN'L AGGREGATE LIMIT APPLIES PER:						GENERAL AGGREC		\$	2,000,000
	X POLICY PRO- JECT LOC						PRODUCTS - COM		\$	2,000,000
	OTHER:								\$	
	AUTOMOBILE LIABILITY						COMBINED SINGLE (Ea accident)	LIMIT	\$	
	ANY AUTO						BODILY INJURY (Pe		s	
	OWNED AUTOS ONLY SCHEDULED AUTOS				1		BODILY INJURY (Pe		\$	
	HIRED NON-OWNED AUTOS ONLY						PROPERTY DAMAG (Per accident)	E	\$	
									\$	
	UMBRELLA LIAB OCCUR						EACH OCCURRENCE	CE	\$	
	EXCESS LIAB CLAIMS-MADE						AGGREGATE		\$	
	DED RETENTION \$								\$	
	WORKERS COMPENSATION AND EMPLOYERS' LIABILITY Y/N						PER STATUTE	OTH- ER		
	ANY PROPRIETOR/PARTNER/EXECUTIVE OFFICER/MEMBER EXCLUDED? (Mandatory in NH)	N/A					E.L. EACH ACCIDE	NT	\$	
							E.L. DISEASE - EA I	MPLOYEE	\$	
_	If yes, describe under DESCRIPTION OF OPERATIONS below						E.L. DISEASE - POL	ICY LIMIT	s	
JES	CRIPTION OF OPERATIONS / LOCATIONS / VEHIC	LES (ACORD	101, Additional Remarks Schedu	ile, may t	e attached If mor	e space is requir	ed)			
CEI	RTIFICATE HOLDER			CAN	CELLATION					
	City of Belle Isle 1600 Nela Avenue			SHO THE ACC	OULD ANY OF T EXPIRATION CORDANCE WI	THE ABOVE DI N DATE TH TH THE POLIC	ESCRIBED POLIC EREOF, NOTICE Y PROVISIONS.	IES BE CA	ANCEL Be de	LED BEFORE ELIVERED IN
	Belle Isle, FL 32809			AUTHORIZED REPRESENTATIVE						



CERTIFICATE OF LIABILITY INSURANCE

DATE (MM/DD/YYYY) 07/15/2019

THIS CERTIFICATE IS ISSUED AS A MATTER OF INFORMATION ONLY AND CONFERS NO RIGHTS UPON THE CERTIFICATE HOLDER. THIS CERTIFICATE DOES NOT AFFIRMATIVELY OR NEGATIVELY AMEND, EXTEND OR ALTER THE COVERAGE AFFORDED BY THE POLICIES BELOW. THIS CERTIFICATE OF INSURANCE DOES NOT CONSTITUTE A CONTRACT BETWEEN THE ISSUING INSURER(S), AUTHORIZED REPRESENTATIVE OR PRODUCER, AND THE CERTIFICATE HOLDER.

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cerui	icate holder in lieu of such endorsement	3).								
RODU	JCER			<u> </u>	CONTACT NAM	IE:				
				E	PHONE (A/C, N	o, Ext): (800) 277-1	620 X 4800	FAX (A/C, No):	(727	797-0704
Frank	Crum Insurance Agency, Inc.			E	E-MAIL ADDRE	SS:				
	South Missouri Avenue					INSURER(S) AFFORDING CO	VERAGE		NAIC#
	water, FL 33756				NSURER A			Insurance Company		11600
NSUF					NSURER B:	11211	· · · · · · · · · · · · · · · · · · ·	modranios company		
NOUR	KED			-					\rightarrow	
					NSURER C:				\rightarrow	
rank	Crum L/C/F Sunlight Enterprises, Inc			<u> </u>	NSURER D:				-	
	South Missouri Avenue			1	NSURER E:					
Clear	water, FL 33756			J	NSURER F:					
				NUMBER: 573				REVISION NUMBER:		
NC PE	IS IS TO CERTIFY THAT THE POLICIES OF INSU TWITHSTANDING ANY REQUIREMENT, TERM I RTAIN, THE INSURANCE AFFORDED BY THE P LY HAVE BEEN REDUCED BY PAID CLAIMS.	OR CON	DITION (OF ANY CONTRACT OR	OTHER DOCL	MENT WITH RESPE	CT TO WHICH TH	IIS CERTIFICATE MAY BE I	ISSUED	OR MAY S SHOWN
INSR LTR	TYPE OF INSURANCE	ADDL INSRD	SUBR WVD	POLICY NUMB	ER	POLICY EFF (MM/DD/YYYY)	POLICY EXP (MM/DD/YYYY)	LIMIT	rs	
	COMMERCIAL GENERAL LIABILITY							EACH OCCURRENCE		\$
	CLAIMS-MADE OCCUR							DAMAGE TO RENTED PREMISES (Ea occurrence)		\$
	DOCOR DOCOR							MED EXP (Any one person)	-	\$
									-	\$
								PERSONAL & ADV INJURY	-	
	GEN'L AGGREGATE LIMIT APPLIES PER:							GENERAL AGGREGATE	\rightarrow	\$
	POLICY PROJECT LOC							PRODUCTS-COMP/OP AGG		\$
	OTHER:							COMPRISE CINIOLE LIMIT	\rightarrow	\$
	AUTOMOBILE LIABILITY							COMBINED SINGLE LIMIT (Ea accident)		\$
	ANY AUTO							BODILY INJURY (Per person)		\$
	OWNED AUTOS SCHEDULED									\$
	ONLY							BODILY INJURY (Per accident PROPERTY DAMAGE	,	
	HIRED AUTOS NON-OWNED AUTOS ONLY							(Per accident)	_	\$
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	DED RETENTION \$								отн-	\$
	WORKERS COMPENSATION AND			WC2019000	000	01/01/2019	01/01/2920	X PER STATUTE	ER	
Α	EMPLOYERS' LIABILITY ANY PROPRIETOR/PARTNER/EXECUTIVE Y/N									
	OFFICER/MEMBER EXCLUDED?	N/A						E.L. EACH ACCIDENT	-	\$1,000,000
	(Mandatory in NH) If yes, describe under							E.L. DISEASE-EA EMPLOYEE		\$1,000,000
	DESCRIPTION OF OPERATIONS below									44.000.000
								E.L. DISEASE-POLICY LIMIT	\dashv	\$1,000,000
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				W.						
ESC	RIPTION OF OPERATIONS / LOCATIONS / VEHIC	LES (A	CORD 10	1, Additional Remarks	Schedule, may	be attached if more	space is required	d)		
ffec	tive 02/13/2019, coverage is for 100%	of the	emplo	vees of FrankCrum	leased to S	Sunlight Enterpri	ses, Inc (Clien	t) for whom the client	is rep	orting hours to
	Crum. Coverage is not extended to st					3	, ,	,	•	•
	to and the contract to the	,	J	,,						
	ISIOATE HOLDED		_		CANCE	TLATION				
-ERT	IFICATE HOLDER	-	_		CANCE	LLATION				
					SHOULD AND	OF THE ABOVE DI	SCRIBED POLICI	ES BE CANCELLED BEFOR	RE THE	
					EXPIRATION	DATE THEREOF, N		ELIVERED IN ACCORDANC		THE
					POLICY PRO					
									_	
	Oit of Della ist				AUTHORIZE	D REPRESENTATIV	E			
	City of Belle isle					20				
	1600 Nela Avenue					1 /00	1	_		
	Pollo Isla El 32800					8 2				

PROJECT DESCRIPTION:

30x295 COOL PV PN:09629 (295W) MODULES AND 08x295 CANADIAN SOLAR CS6K 295MS (295W) MODULES ROOF MOUNTED SOLAR PHOTOVOLTAIC MODULES

SYSTEM SIZE: 11.21 kW DC STC ARRAY AREA #1 : 542.70 SQ FT. ARRAY AREA #2 : 141.20 SQ FT.

EQUIPMENT SUMMARY

COOL PV PN:09629 (295W) MODULES AND HANWHA Q.PEAK BLK-G4.1 (295W) MODULES **ENPHASE IQ7-60-2-US MICROINVERTERS**

SHEET INDEX

A-00 PLOT PLAN & VICINITY MAP SYMBOLS & SYSTEM DESCRIPTION A-01 S-01 **ROOF PLAN & MODULES** S-02 STRUCTURAL ATTACHMENT DETAILS E-01 ELECTRICAL LINE DIAGRAM E-02 WIRING CALCULATIONS E-02.1 WIRING CALCULATIONS E-03 SYSTEM LABELING


DS-01 DATA SHEET DATA SHEET DS-02 DATA SHEET DS-03 DATA SHEET DS-04 DS-05 DATA SHEET DATA SHEET DS-06


GOVERNING CODES:

FLORIDA RESIDENTIAL CODE, 6TH EDITION 2017 (FRC) FLORIDA PLUMBING CODE, 6TH EDITION 2017 (FPC) FLORIDA BUILDING CODE, 6TH EDITION 2017 EDITION (FBC) FLORIDA MECHANICAL CODE, 6TH EDITION 2017 (FMC) NEC 2014 CODE BOOK



HOFFNER AVE

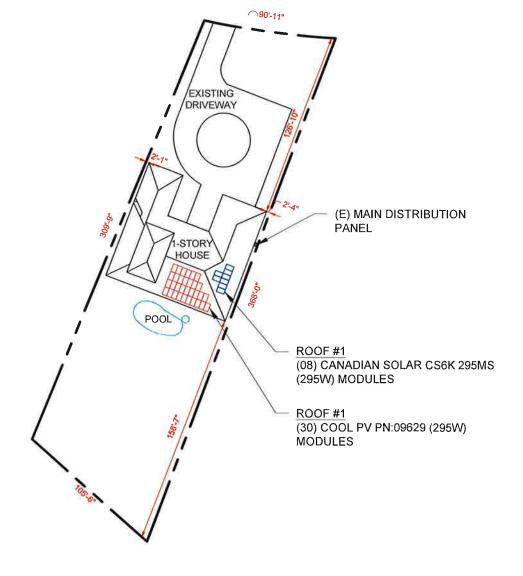

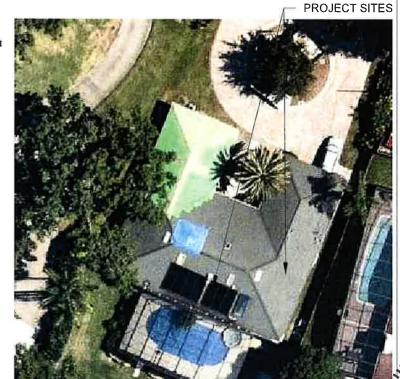



Castillo (

Engineering 🕓

HOUSE PHOTO Reviewed for Code A-00 SCALE: NTS Compliance niversal Engineering PROJECT SITE Union Park (423) (30) Pine Hills (526) Azolea Park (526) Orlando 417 042 Hoffner Avenue VISTA LAST Pine Castle Oak Ridge (15) Orlando International SOUTHEAST

Huntern Creek 3 VICINITY MAP A-00 SCALE: NTS

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PLOT PLAN WITH ROOF PLAN

SHEET NUMBER A-00

SHEET NAME **PLOT PLAN &** VICINITY MAP

> SHEET SIZE ANSI B

11" X 17"

RESIDENCE


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2 AVE, 32812

3042 HOFFNER BELLE ISLE, FL (

A-00

SCALE: 1/64" = 1'-0"

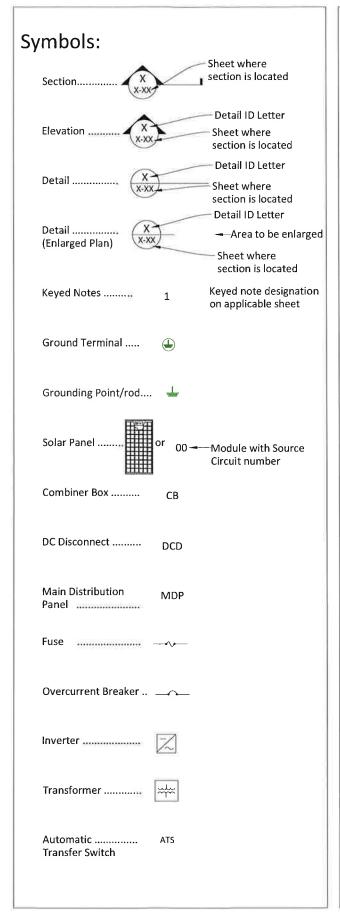


Abbreviations:

AC	Alternating Current
APPROX	Approximate
AWG	American Wire Gauge
СВ	Combiner Box
DC	Direct Current
DCD	Direct Current Disconnect
DISC	Disconnect
(E)	Existing
EL	Elevation
EQ	Equal
JB	Junction Box
MCB	Main Combiner Box
MFR	Manufacturer
MIN	Minimum
MISC	Miscellaneous
(N)	New
OCPD	OverCurrent Protection Device
POCC	Point Of Common Coupling
PV	Photovoltaic
SF	Squarefoot/feet
STC	Standard Test Conditions
TBD	To Be Determined
TYP	Typical
VIF	Verify In Field
WP	Weather Proof

System Description

This system is a grid-tied, PV system, with PV generation consisting of 30 COOL PV PN:09629 (295W) MODULES AND 08 CANADIAN SOLAR CS6K 295MS (295W) MODULES with a combined STC rated dc output power of 11,210W. The modules are connected into 38 ENPHASE IQ7-60-2-US MICROINVERTERS. The inverter has electronic maximum power point tracking to maximize energy captured by the PV modules. The inverter also has an internal ground fault detection and interruption device that is set to disconnect the array in the event that a ground fault that exceeds one ampere should occur. The inverter has DC and AC disconnect integrated system and labels are provided as required by the *National Electric Code*

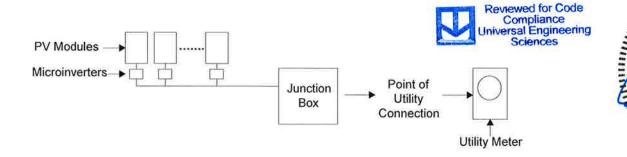

When the sun is shining, power from the PV array is fed into the inverter, where it is converted from DC to AC. The inverter output is then used to contribute to the power requirements of the occupancy. If PV power meets the requirements of the loads of the occupancy, any remaining PV power is sold back to the utility. When utility power is available, but PV power is not available, building loads are supplied by the utility.

The inverter meets the requirements of IEEE 1547 and UL 1741. This means that if it detects a loss of utility power, it will automatically disconnect from the utility. When utility voltage is restored, the inverter automatically reconnects to the utility grid after verifying utility voltage and frequency stability.

On a day with average Florida sunshine, this system outputs 45.58 kWh per day on site.



CASTILLO ENGINEERING SERVICES, LLC COA# 28345 2925 W, STATE ROAD 434,

2925 W. STATE ROAD 434, SUITE 111 LONGWOOD, FL 32779 TEL: (407) 289-2575 ERMOCRATES E. CASTILLO - FL PE 52590

REVIS	IONS	
DESCRIPTION	REV	



SHEET NAME
SYMBOLS &
SYSTEM
DESCRIPTION


SHEET SIZE


ANSI B

11" X 17"

SHEET NUMBER
A-01

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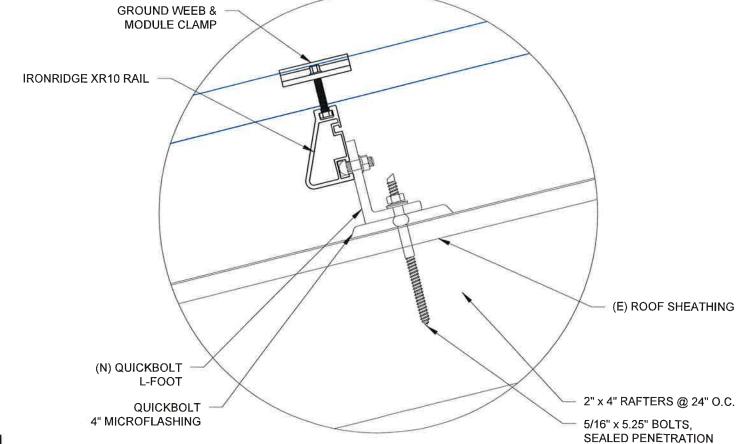


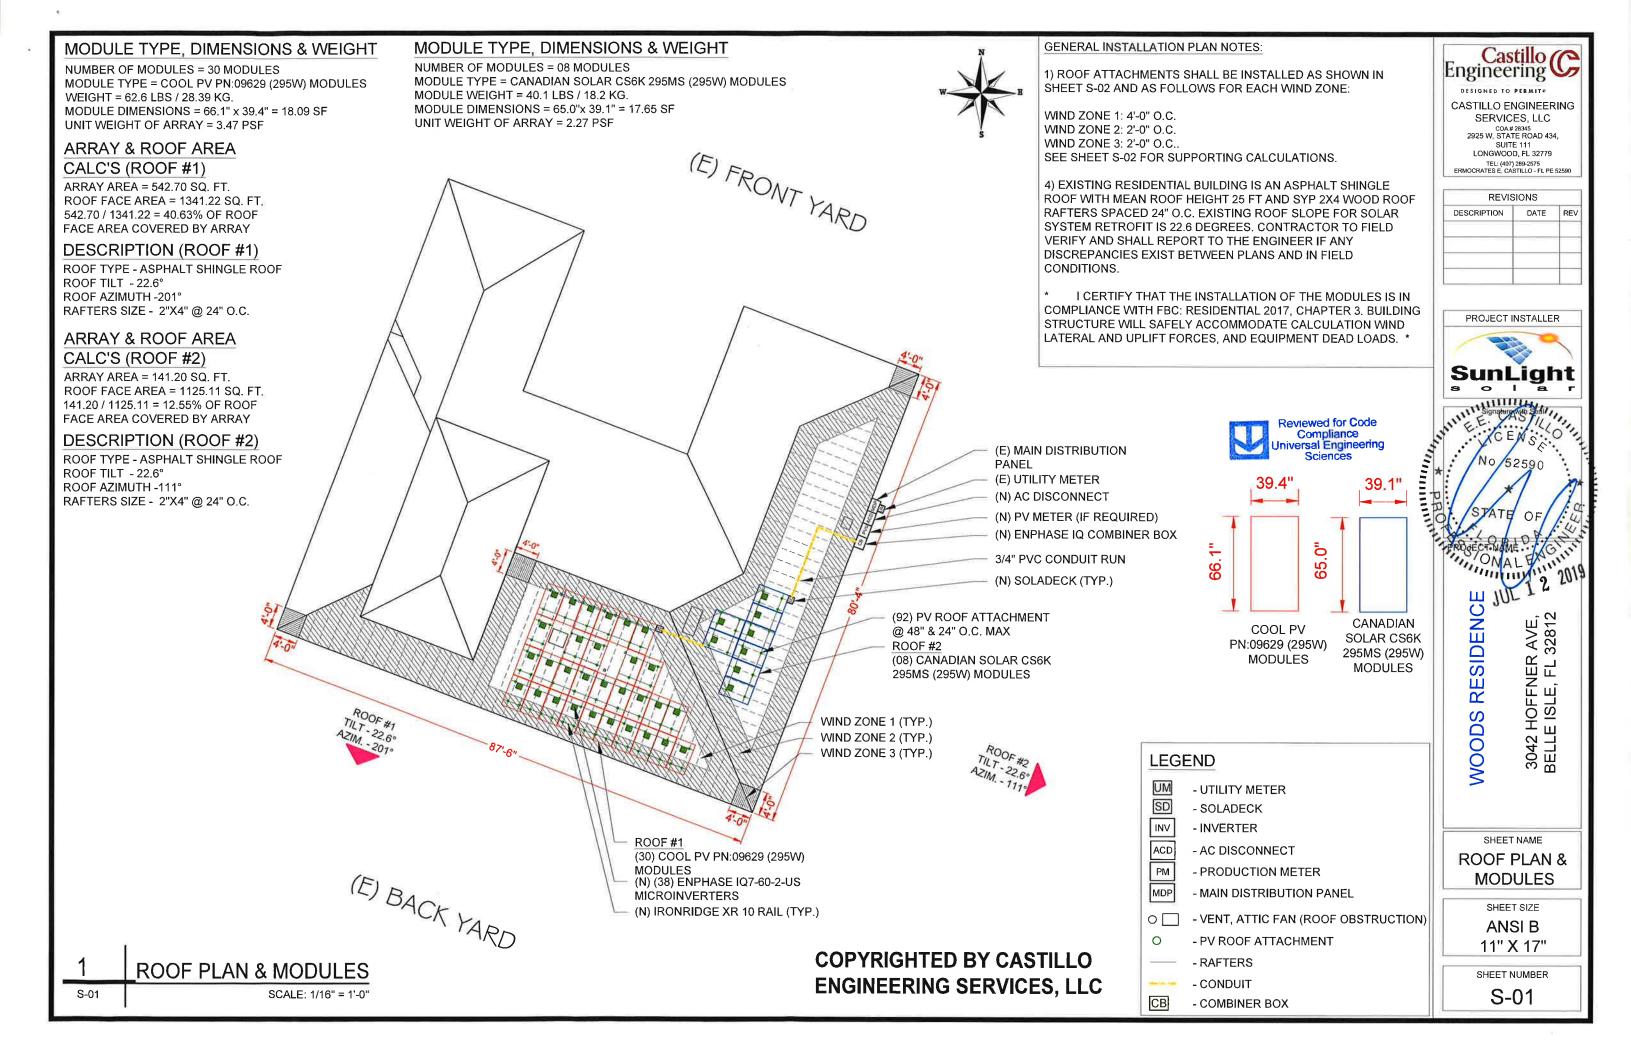

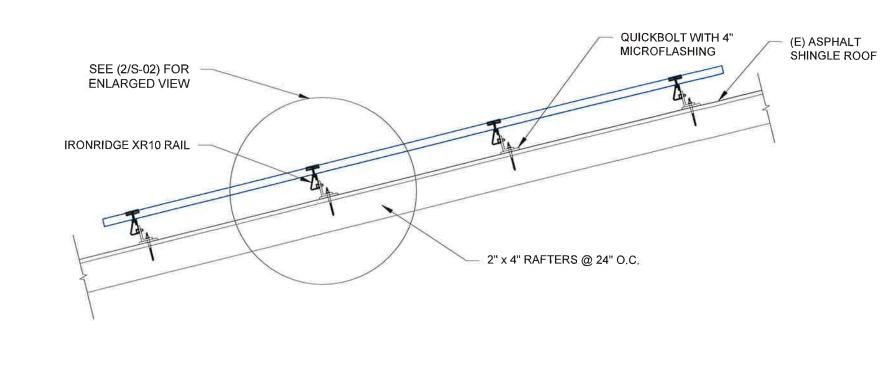ATTACHMENT DETAIL

S-02 SCALE - 1" = 1'-0"

S-02



SCALE: NTS

ATTACHMENT DETAIL (ENLARGED SECTION VIEW)

Notes:

1. Values are utilimize design 3-second gust wind speeds in alles per hour (w/s) at 33 ft (18m) above ground for Exposure C category.

2. Linear interpolation between contours is permitted.

3. Islands and coastal areas outside the last contour shall use the last wind speed contour of the coastal area.

4. Mountainous corrain, gorges, occean promontories, and special wind regions shall be examined for unusual wind conditions.

5. Mind speeds correspond to sproximately a 7% probability of exceedance in 50 years (Annual Exceedance Probability = 0.00149, MRI = 700 years).

FIGURE 1609.3(1)

ULTIMATE DESIGN WIND SPEEDS, V_{ULT} , FOR RISK CATEGORY II BUILDINGS AND OTHER STRUCTURES

Wind Speed Ult (mph)	140
Risk Category	- 11
Wind Speed ASD (mph)	110
Exposure Category	D
Mean Roof Height (ft)	25
Roof Slope (degrees)	25
Module Area (sq ft)	20
Kzt	1
Helght Adjustment Factor, λ	1.61

Roof Zone	Pne	t (30)
1	11.4	-19.4
2	11.4	-31.9
3	11.4	-47.9

$P_net=[\lambda K]_ztP_(net(30))$

Roof Zone	Pnet			
1	18.354	-31.234		
2	18.354	-51.359		
3	18.354	-77.119		

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ENGINEERING SERVICES, LLC

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	and the second s	

	oof Slope Calcu	il George
Rise	Run	Slope (°)
5	12	22.6

Maximum Uplift per	343.6
*fastener Wind Zone 1	
Per American Wood Council -	
NDS Max Withdraw Load for	476
5/16" LAG with 2.5"	4/0
Embedment	

*Roof attachements w 2 rails at: 4 ft O/C

Maximum Uplift per *fastener Wind Zone 2	282.5
Per American Wood Council - NDS Max Withdraw Load for 5/16" LAG with 2.5" Embedment	476

*Roof attachements w 2 rails at: 2 ft O/C

Maximum Uplift per *fastener Wind Zone 3	424.2
Per American Wood Council - NDS Max Withdraw Load for 5/16" LAG with 2.5" Embedment	476

*Roof attachements w 2 rails at: 2 ft O/C

Castillo C Engineering C

DESIGNED TO PERMIT

CASTILLO ENGINEERING SERVICES, LLC COA # 28345 2925 W, STATE ROAD 434,

SUITE 111 LONGWOOD, FL 32779 TEL: (407) 299-2575 ERMOCRATES E, CASTILLO - FL PE 52590

REVISIONS					
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SunLight

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WOODS

3042 HOFFNER / BELLE ISLE, FL 3

SHEET NAME STRUCTURAL ATTACHMENT DETAILS


SHEET SIZE

ANSI B

11" X 17"

SHEET NUMBER

S-02

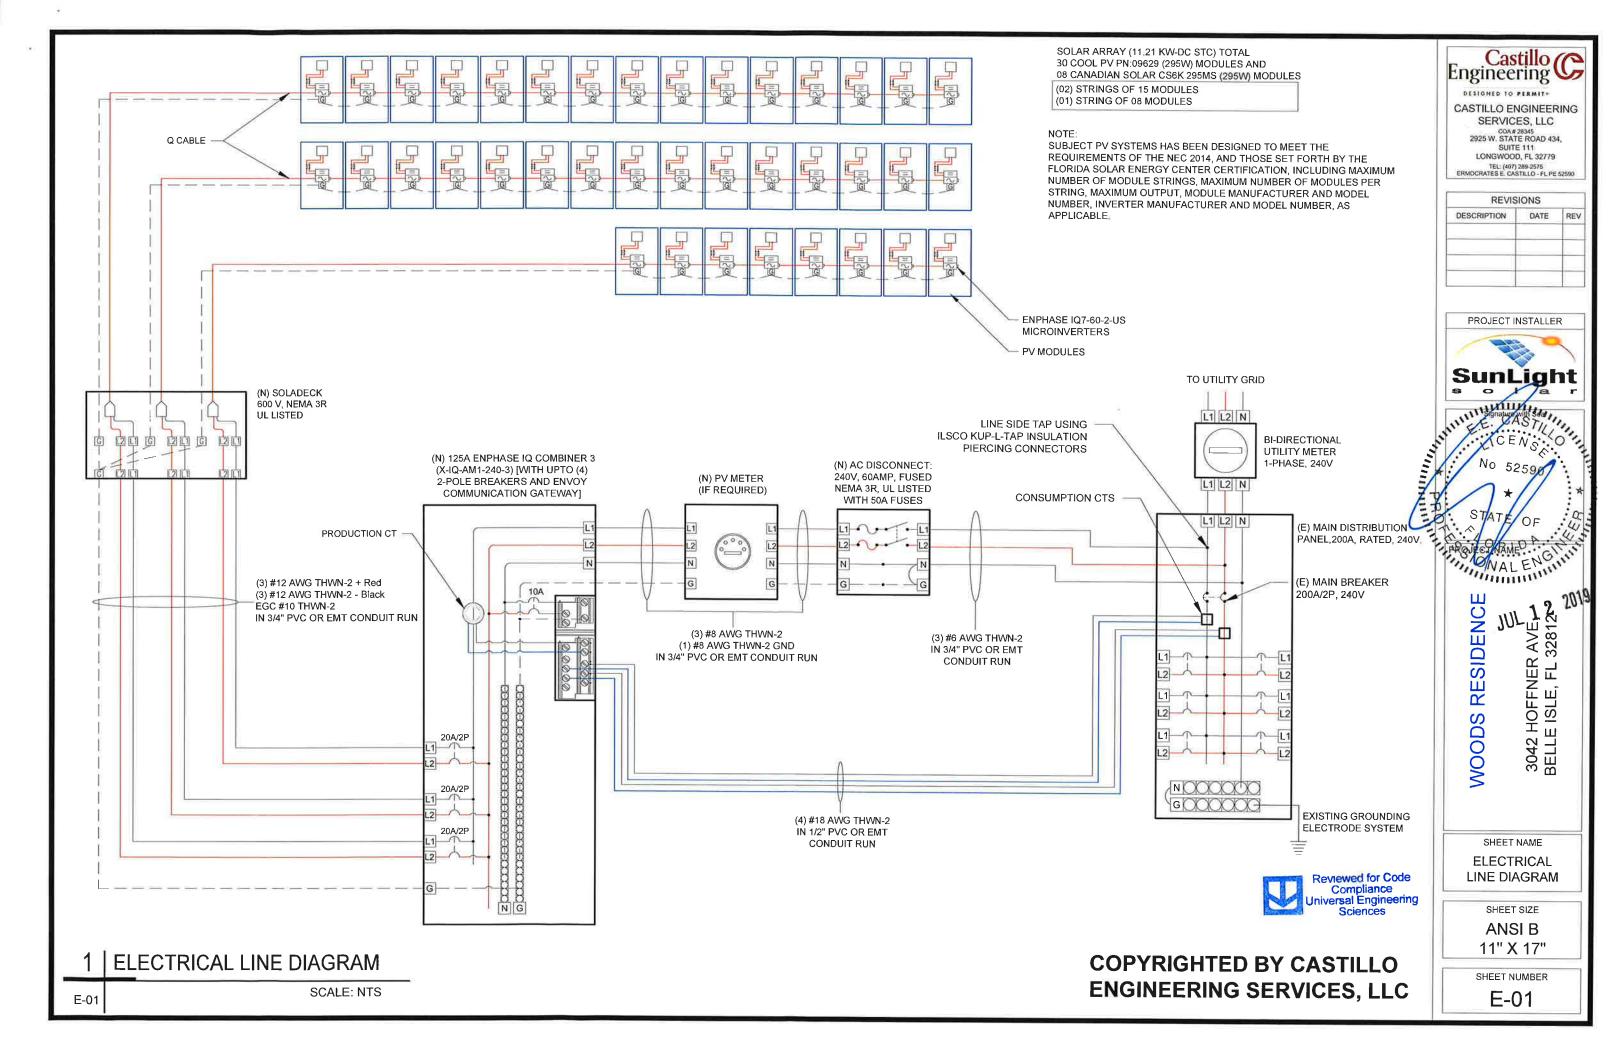

AC CONDUCTOR AMPACITY CALCULATIONS: FROM ROOF TOP SOLADECK TO LOAD CENTER

MODULE MANUFACTURER	SOLARWORLD		
MODULE MODEL	SW 295 MONO		
INVERTER MANUFACTURER	ENPHASE		
INVERTER MODEL	ENPHASE IQ 7		
CIRCUIT 2 (COOL PV W/			
SOLARWORLD 295W)	15		
CIRCUIT 2 (COOL PV W/	15		
SGLARWORLD 295W)	1.5		
TOTAL ARRAY POWER (KW)	8.85		
SYSTEM AC VOLTAGE	240V 1-PHASE		

DEBIGN TEMPERATURE				
MIN. AMBIENT TEMP. °F	32			
MAX. AMBIENT TEMP. °F	117			
CALCULATED MAX. VOC	43			
CALCULATED MIN VMP	26			

AC CONDUCTOR AMPACITY CALCULATIONS: FROM AC COMBINER BOX TO MSP

	MODULE PROFERTIES								
Voc 39.8 (ac 9.7)									
VMPP	32.3	IMP	9.25						
TC Voc	-0.29% /°C	TC VMP	-0.39%/ °C						
РмР	295.0	NOCT	45 °C						

INVERTER PROPERTIES					
OUTPUT VOLTAGE	240 L-L 1-PH				
MAX INPUT DC VOLTABE	48 Voc				
OPERATING RANGE	16 - 48 VDC				
MPPT VOLTAGE RANGE	27 - 37 Voc				
START VOLTAGE	22 Vác				
MAX INPUT POWER	350 Woc				
CONTINUQUE AC POWER	240 VA				

AMPACITY	CALCULTIONS									
CIRCUIT	вчмА хам	1.25 x MAX AMPS	AWG	90 °C AMPACITY	AMBIENT TEMP °F	TEMP DERATE	CONDUIT FILL	FILL DERATE	DERATED AMPACITY	MAXIMUM CIRCUIT BREAKER
CIRCUIT 1	15.0	18.8	#12	30	130	D.76	2	1	22.8	20 A
CIRCUIT 2	15.0	19.8	#12	30	130	0.76	2	1	22.8	20 A
AC COMBINER PANEL OUTPUT	30.0	37.5	#8	55	95	0.96	2	1	52.8	4D A

MAXIMUM CIRCUIT VOLTABE DROP 2%

INFORMATON OBTAINED FROM MANUFACTURER DATASHEETS

VOLTAGE DROP CALCULATIONS					
CIRCUIT	AWG	CIRCULAR MILLS	1	v	MAX LENDTH
CIRCUIT 1	#12	6530	15.0	240	S1 FEET
CIRCUIT 2	#12	6530	15.0	240	B1 FEET
COMBINER PANEL OUTPUT	#8	16510	30.0	240	102 FEET

NOTES

CALCULATIONS HAVE SEEN BASED ON SOLARWORLD 295W MODULE TO ACCOUNT FOR HIGHEST AMPERAGE AS WORST CASE SCENARIO
TEMP DERATE BASED ON NEC TABLE 310.15(8)(2)(A)

CONDUIT FILL DERATE BASED ON NEC TABLE 310.15(8)(3)(A)

MAXIMUM VOC CALCULATED USING MODULE MANUFACTURE TEMPERATURE COEFFICIENTS PER NEC 690.7(A)

UNLESS OTHERWISE SPECIFIED, ALL WIRING MUST SE THHN OR THWN-2 COPPER

ALL WIRE SIZES LISTED ARE THE MINIMUM ALLOWASLE

IN ANY CELL INDICATES THAT THE SYSTEM IS SAFE AND COMPLIES WITH NEC REQUIREMENTS

IN ANY CELL INDICATES A POTENTIALLY UNBAFE CONDITION

INFORMATION INPUT BY SYSTEM DESIGNER

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ELECTRICAL NOTES


- 1. ALL EQUIPMENT TO BE LISTED BY UL OR OTHER NRTL, AND LABELED FOR ITS APPLICATION.
- 2. ALL CONDUCTORS SHALL BE COPPER, RATED FOR 600 V AND 90 DEGREE C WET ENVIRONMENT.
- 3. WIRING, CONDUIT, AND RACEWAYS MOUNTED ON ROOFTOPS SHALL BE ROUTED DIRECTLY TO, AND LOCATED AS CLOSE AS POSSIBLE TO THE NEAREST RIDGE, HIP, OR VALLEY.
- WORKING CLEARANCES AROUND ALL NEW AND EXISTING ELECTRICAL EQUIPMENT SHALL COMPLY WITH NEC 110.26.
- DRAWINGS INDICATE THE GENERAL ARRANGEMENT OF SYSTEMS. CONTRACTOR SHALL FURNISH ALL NECESSARY OUTLETS, SUPPORTS, FITTINGS AND ACESSORIES TO FULFILL APPLICABLE CODES AND STANDARDS.
- 6. WHERE SIZES OF JUNCTION BOXES, RACEWAYS, AND CONDUITS ARE NOT SPECIFIED, THE CONTRACTOR SHALL SIZE THEM ACCORDINGLY.
- 7. ALL WIRE TERMINATIONS SHALL BE APPROPRIATELY LABELED AND READILY VISIBLE.
- MODULE GROUNDING CLIPS TO BE INSTALLED BETWEEN MODULE FRAME AND MODULE SUPPORT RAIL, PER THE GROUNDING CLIP MANUFACTURER'S INSTRUCTION.
- . MODULE SUPPORT RAIL TO BE BONDED TO CONTINUOUS COPPER G.E.C. VIA WEEB LUG OR ILSCO GBL-4DBT LAY-IN LUG.
- 10. THE POLARITY OF THE GROUNDED CONDUCTORS IS NEGATIVE.
- 11. UTILITY HAS 24-HR UNRESTRICTED ACCESS TO ALL PHOTOVOLTAIC SYSTEM COMPONENTS LOCATED AT THE SERVICE ENTRANCE.
- 12. MODULES CONFORM TO AND ARE LISTED UNDER UL 1703.
- 13. RACKING CONFORMS TO AND IS LISTED UNDER UL 2703.
- 14. CONDUCTORS EXPOSED TO SUNLIGHT SHALL BE LISTED AS SUNLIGHT RESISTANT PER NEC ARTICLE 300.6 (C) (1) AND ARTICLE 310.10 (D).
- 15. CONDUCTORS EXPOSED TO WET LOCATIONS SHALL BE SUITABLE FOR USE IN WET LOCATIONS PER NEC ARTICLE 310,10 (C).



Input Data (DC		
	Recommended Input Power (STC)	235-350W +
	Maximum Input DC Voltage	48V
	Peak Power Tracking Voltage	27V-37V
	Operating Range	16V-48V
	Min. / Max. Start Voltage	22V / 48V
	Max DC Short Circuit Current	15A
Output Data (A	C)	1
	Maximum Output Power	240W
	Nominal Output Current	1.0A
	Nominal Voltage / Range	240V/211-264V
	Nominal Frequency / Range	60 Hz
	Extended Frequency / Range	47-68 Hz
	Power Factor at rated power	1.0
	Maximum unit per 20A Branch Circuit	16 (240 VAC)



REVIS	IONS	
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ANSI B 11" X 17"

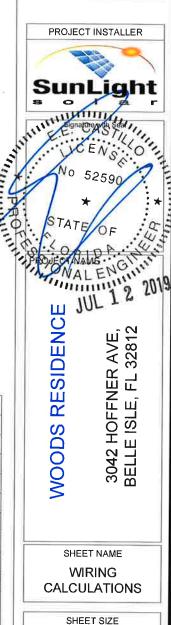SHEET NUMBER

E-02

AC CONDUCTOR AMPACITY CALCULATIONS: FROM ROOF TOP SOLADECK TO LOAD CENTER

MODULE MANUFACTURER	CANADIAN SOLAR
MODULE MODEL	C66K-295M8
INVERTER MANUFACTURER	ENPHASE
INVERTER MODEL	ENPHASE IQ 7
MODULES/BRANCH CIRCUIT 1	8
TOTAL ARRAY POWER (KW)	2.36
SYSTEM AC VOLTAGE	240V 1-PHASE

DESIGN TEMPERATURE				
MIN. AMBIENT TEMP. °F	32			
MAX. AMBIENT TEMP. °F	117			
CALCULATED MAX. VOO	43			
CALCULATED MIN VMP	26			

AC CONDUCTOR AMPACITY CALCULATIONS: FROM AC COMBINER BOX TO MSP

MODULE PROPERTIES						
Voc	39.5	lac	9.75			
VMPP	32.5	IMP	9.14			
TC Voc	-D.30%/ °C	TC VMP	-0.39%/ °C			
PMP	295.0	NOCT	45 °C			

INVERTER PROPERTIES					
OUTPUT VOLTAGE	240 L-L 1-PH				
MAX INPUT DC VOLTAGE	48 VDC				
OPERATING RANGE	16 - 46 VDG				
MPPT VOLTAGE RANGE	27 - 37 Voc				
START VOLTAGE	22 VDQ				
MAX INPUT POWER	350 Woo				
CONTINUOUS AC POWER	240 VA				

AMPACITY	CALCULTIONS				×					
CIRCUIT	Мах Амрв	1.25 X MAX AMP8	AWG	90 °C AMPACITY	AMBIENT TEMP °F	TEMP DERATE	CONDUIT FILL	FILL DERATE	DERATED AMPACITY	MAXIMUM CIRCUIT BREAKER
CIRCUIT 1	8.0	10.0	#12	30	130	0.76	2	1	22,8	20 A
AC COMBINER PANEL OUTPUT	8.0	10.0	#10	40	95	0.96	2	1	38.4	20 A

MAXIMUM GIRCUIT VOLTAGE DROP

VOLTAGE DROP CALCULATIONS			11		
CIRCUIT	AWG	CIRCULAR MILLS	I	v	MAX LENGTH
CIRCUIT 1	#12	6530	8.0	240	152 FEET
COMBINER PANEL OUTPUT	#10	10380	8.0	240	241 FEET

NOTES

TEMP DERATE BASED ON NEC TABLE 310.15(8)(2)(A)

CONDUIT FILL DERATE BASED ON NEC TABLE 310.15(B)(3)(A)

MAXIMUM VOC CALCULATED USING MODULE MANUFACTURE TEMPERATURE COEFFICIENTS PER NEC 690.7(A)

UNLESS OTHERWISE SPECIFIED, ALL WIRING MUST BE THHN OR THWN-2 COPPER

ALL WIRE BIZES LISTED ARE THE MINIMUM ALLOWABLE

IN ANY CELL INDICATEB THAT THE BYBTEM IB BAFE AND COMPLIEB WITH NEC REQUIREMENTB

IN ANY CELL INDICATES A POTENTIALLY UNSAFE CONDITION

INFORMATION INPUT BY SYSTEM DESIGNER

INFORMATON OBTAINED FROM MANUFACTURER DATABHEETS

ELECTRICAL NOTES

- 1. ALL EQUIPMENT TO BE LISTED BY UL OR OTHER NRTL, AND LABELED FOR ITS APPLICATION.
- ALL CONDUCTORS SHALL BE COPPER, RATED FOR 600 V AND 90 DEGREE C WET ENVIRONMENT.
- WIRING, CONDUIT, AND RACEWAYS MOUNTED ON ROOFTOPS SHALL BE ROUTED DIRECTLY TO, AND LOCATED AS CLOSE AS POSSIBLE TO THE NEAREST RIDGE, HIP, OR VALLEY.
- 4. WORKING CLEARANCES AROUND ALL NEW AND EXISTING ELECTRICAL EQUIPMENT SHALL COMPLY WITH NEC 110.26.
- DRAWINGS INDICATE THE GENERAL ARRANGEMENT OF SYSTEMS. CONTRACTOR SHALL FURNISH ALL NECESSARY OUTLETS, SUPPORTS, FITTINGS AND ACESSORIES TO FULFILL APPLICABLE CODES AND STANDARDS.
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- MODULE SUPPORT RAIL TO BE BONDED TO CONTINUOUS COPPER G.E.C. VIA WEEB LUG OR ILSCO GBL-4DBT LAY-IN LUG.
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- 13. RACKING CONFORMS TO AND IS LISTED UNDER UL 2703.
- 14. CONDUCTORS EXPOSED TO SUNLIGHT SHALL BE LISTED AS SUNLIGHT RESISTANT PER NEC ARTICLE 300.6 (C) (1) AND ARTICLE
- 15. CONDUCTORS EXPOSED TO WET LOCATIONS SHALL BE SUITABLE FOR USE IN WET LOCATIONS PER NEC ARTICLE 310.10 (C).



ENPHASE IQ7-6	60-2-US MICROINVERTER	
Input Data (DC)		
	Recommended Input Power (STC)	235-350W +
	Maximum Input DC Voltage	48V
	Peak Power Tracking Voltage	27V-37V
	Operating Range	16V-48V
	Min. / Max. Start Voltage	22V / 48V
	Max DC Short Circuit Current	15A
Output Data (AC	;)	· -
	Maximum Output Power	240W
	Nominal Output Current	1.0A
	Nominal Voltage / Range	240V/211-264V
	Nominal Frequency / Range	60 Hz
	Extended Frequency / Range	47-68 Hz
	Power Factor at rated power	1.0
	Maximum unit per 20A Branch Circuit	16 (240 VAC)



TEL: (407) 289-2575 ERMOCRATES E. CASTILLO - FL PE 52590

REVISIONS			
DESCRIPTION	DATE	REV	
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		-	



CALCULATIONS

SHEET SIZE ANSI B

11" X 17"

SHEET NUMBER E-02.1

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WARNING

ELECTRIC SHOCK HAZARD

DO NOT TOUCH TERMINALS
TERMINALS ON BOTH LINE AND
LOAD SIDES MAY BE ENERGIZED
IN THE OPEN POSITION

ABEL LOCATION:

AC DISCONNECT, POINT OF INTERCONNECTION PER CODE: NEC 690.17(E), CB

WARNING: PHOTOVOLTAIC POWER SOURCE

LABEL LOCATION: CONDUIT, COMBINER BOX (PER CODE: NEC690.31(G)(3)(4) & NEC 690.13(G)(4)

WARNING DUAL POWER SOURCE SECOND SOURCE IS PHOTOVOLTAIC SYSTEM

LABEL LOCATION:
POINT OF INTERCONNECTION
(PER CODE: NEC 705.12(D)(4))

ADHESIVE FASTENED SIGNS:

THE LABEL SHALL BE SUITABLE FOR THE ENVIRONMENT WHERE IT IS INSTALLED.

WHERE REQUIRED ELSEWHERE IN THIS CODE, ALL FIELD APPLIED LABELS, WARNINGS, AND MARKINGS SHOULD COMPLY WITH ANSI Z535,4 [NEC 110.21(B) FIELD MARKING].

ADHESIVE FASTENED SIGNS MAY BE ACCEPTABLE IF PROPERLY ADHERED. VINYL SIGNS SHALL BE WEATHER RESISTANT (IFC 605 11 1 3)

PHOTOVOLTAIC SYSTEM AC DISCONNECT RATED AC OPERATING CURRENT 38.0 AMPS AC NOMINAL OPERATING VOLTAGE 240 VOLTS

LABEL LOCATION:
AC DISCONNECT, POINT OF INTERCONNECTION
(PER CODE: NEC690,54)

WARNING

INVERTER OUTPUT CONNECTION DO NOT RELOCATE THIS OVERCURRENT DEVICE

LABEL LOCATION:
POINT OF INTERCONNECTION
(PER CODE: NEC 705.12(D)(7))
[Not required if panelboard is rated not less than sum of ampere ratings of all overcurrent devices supplying it]

DATA PER PANEL

NOMINAL OPERATING AC VOLTAGE -	240	V
NOMINAL OPERATING AC FREQUENCY-	60	Hz
MAXIMUM AC POWER-	295	VA
MAXIMUM AC CURRENT-	1.0	Α
MAXIMUM OVERCURRENT DEVICE RATING FOR AC MODULE PROTECTION PER CIRCUIT-	20	Α

LABEL LOCATION: COMBINER BOX (PER CODE: NEC690,52)

PHOTOVOLTAIC SYSTEM EQUIPPED WITH RAPID SHUTDOWN

LABEL LOCATION:
AC DISCONNECT, DC DISCONNECT, POINT OF INTERCONNECTION
(PER CODE: NEC690,56(C))



CASTILLO ENGINEERING SERVICES, LLC COA# 28345

COA # 28345 2925 W. STATE ROAD 434, SUITE 111 LONGWOOD, FL 32779 TEL: (407) 289-2575 ERMOCRATES E. CASTILLO - FL PE 52590

REVISIONS	
DATE	REV





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LABELING
SHEET SIZE

ANSI B 11" X 17"

SHEET NAME
SYSTEM

SHEET NUMBER
E-03



Frame Cross Section A-A



Mounting Hole

SUPERPOWER

Canadian Solar's new SuperPower modules with ELEGORIERAL COMEA: KENTUCANTLY improve efficiency

DESCRIPTION OF THE PROPERTY OF THE PERSON OF COLUMN	ay mipiove	chickency	
&66Keliability. The innovat	ive 2.60 0 M 1630 lo	gy 2961MS	300MS
Marcinial Marci Pardien (Perpara)	rfo r2∄8rW e ii	n t 29 5 W	300 W
Oppt:rOperatiolge/ellengies@/em	nnjo 332c1o¥udy	da3y2s3V	32.5 V
OpteOpiergiting Ewergyto(Intip	n)it ef05nAm	od@le4aAd	9.24 A
Operaveiralliy Nebdtarget (Next) la	rsy&£&nt/.	39.5 V	39.7 V
Short Circuit Current (Isc)	9.67 A	9.75 A	9.83 A
Module Efficiency	17.72%	18.02%	18.33%
Operating Temperature	-40°C ~ +	85°C	
Wax FaysteineVoltage	1000 V (I	EC) or 1000	V (UL)
Module Fire Performance	TYPE 1 (L	JL 1703) or	

11 % more power than SS C (IEC 61730) Max Series Enswerational modulesA

Application Classification Class A Power Tolerance 0~+5W

Adar Excellent in the formance at lower and ance in an unger standard EXSELLENT DE SOL 1.5 and self temporation \$0.97.5 %

ELECTRICAL DATA / NOCT*

CS6Kin \	High PTC rating of	apoms	295MS	300MS
	Ma911957///er (Pmax)	210 W	213 W	216 W
Opt. Ope	rating Voltage (Vmp)	29.0 V	29.2 V	29.4 V
Opt. Oper	rating Current (Imp)	7.25 A	7.30 A	7.35 A
Open Circ	cuillivipitoged/loog)rgy	pB6dLl\tion	dBi6.40/low	36.6 V
Short Circ	cuitt £unp er att(Ise)coeff	A#RADI	7.83 A	7.92 A

* Under Nominal Operating Cell Temperature (NOCT), irradiance of 800 W/m², um AM 1.5, ambient temperature 20°C, wind speed 1 m/s.

IP67 junction box for long-term

IP67 junction box for long-terrormandenteleviorentelevio

Excellent performance at low irradiance, with an average relative efficiency of 97.5 % from irradiances,

between 2001/May 25mm/1000 World (ANOTES, 25°C).

wind load up to 4000 Pa * The specification and key features described in this datasheet may deviate slightly and are not guaranteed. Due to on-going innovation, research and product enhancement, Canadian Solar Inc. reserves the right to make any adjustment to the information described herein at any time without notice. Please always obtain the most recent version of the datasheet which shall be duly incorporated. into the binding contract made by the parties governing all transactions related to the purchase and sale of the products described herein.

Caution: For professional use only. The installation and handling of PV modules requires professional skills and should only be performed by qualified professionals. Please read the safety and installation installation that the helps are for a vising the modules.

"CanadianSolar 5 10 15 1000 W/m² 5°C 🗒 B00 W/m² 25°C 600 W/m³ 45°C 関 65°C 📕 MECHANICA Specificatio Cell Type Cell Arrangement 1650 x 992 x 40 mm (65.0 x 39.1 x 1.57 in) Dimensions 18.2 kg (40.1 lbs) Weight Front Cover 3.2 mm tempered glass Frame Mateliabar pownodizedpakumimiumtalloy IP67, 3 diodes 4 mm² (IEC) or 4 mm² & 12 AWG Cable 1000 V (UL), 1000 mm (39.4 in) Connector product Matter/ULbn materials PerPallet and worldinpiedes 520 kg (1146.4 lbs) Per Container (40' HQ) 728 pieces

MANAGEMENT SYSTEM CERTIFICATES*

ISO 9001:2008 / Quality management system

ISM BERATURE GHARA GFERIGTIGE Ital management system

Temp. Coefficient (Pmax)	-0.39 % / °C
Peop.ucefferene (ved)ES*	-0.30 % / °C
Thereps (Goodficiento (Isio)-Rheinland / VD	DE / CE / MOCODBORNAL CJET

UL 1703; CSA / IEC 61701 ED2; VDE / IEC 62716; VDE

UNI 9177 Reaction to Fire: Class 1

IEC 60068-2-68: SGS








As there are different certification requirements in different markets, please contact your local Canadian Solar sales representative for the specific certificates applicable to the products in the region in which the products are to be used.

CANADIAN SOLAR (USA), INC. is committed to providing high quality solar products, solar system solutions and services to customers around the world. As a leading PV project developer and manufacturer of solar modules with over 17 GW deployed around the world since 2001, Canadian Solar Inc. (NASDAQ: CSIQ) is one of the most bankable solar companies worldwide.

CANADIAN SOLAR (USA): INC.

LABONDEMNING(SIAN)(USIA))(INCAQ)aBaan(ARO)(T), AUA;jqttSAY@858864A85Md,dwlwAvoodnatdDatas/leest0/56564P][_btales.us@canadiansolar.com

ENGINEERING DRAWING (mm)

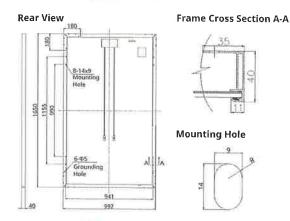

ELECTRICAL DATA / CTC+

ELECTRICAL DATA / STC*			
CS6K	290MS	295MS	300MS
Nominal Max. Power (Pmax)	290 W	295 W	300 W
Opt. Operating Voltage (Vmp)	32.1 V	32.3 V	32.5 V
Opt. Operating Current (Imp)	9.05 A	9.14 A	9.24 A
Open Circuit Voltage (Voc)	39.3 V	39.5 V	39.7 V
Short Circuit Current (Isc)	9.67 A	9.75 A	9.83 A
Module Efficiency	17.72%	18.02%	18.33%
Operating Temperature	-40°C +	85°C	
Max. System Voltage	1000 V (II	EC) or 1000	V (UL)
Module Fire Performance	TYPE 1 (L	JL 1703) or	A * * 1 A * *
	CLASS C	(IEC 61730)	
Max. Series Fuse Rating	15 A		
Application Classification	Class A		
Power Tolerance	0~+5W		

 Under Standard Test Conditions (STC) of irradiance of 1000 W/m², spectrum AM 1,5 and cell temperature of 25°C

ELECTRICAL DATA / NOCT*

290MS	295MS	300MS
210 W	213 W	216 W
29.0 V	29.2 V	29.4 V
7.25 A	7.30 A	7.35 A
36.2 V	36.4 V	36.6 V
7.74 A	7.83 A	7.92 A
	210 W 29.0 V 7.25 A 36.2 V	210 W 213 W 29.0 V 29.2 V 7.25 A 7.30 A 36.2 V 36.4 V

* Under Nominal Operating Cell Temperature (NOCT), Irradiance of 800 W/m², spectrum AM 1.5, ambient temperature 20°C, wind speed 1 m/s.


PERFORMANCE AT LOW IRRADIANCE

Excellent performance at low irradiance, with an average relative efficiency of 97.5 % from irradiances, between 200 W/m² and 1000 W/m² (AM 1.5, 25°C).

The specification and key features described in this datasheet may deviate slightly and are not guaranteed. Due to on-going innovation, research and product enhancement, Canadian Solar Inc. reserves the right to make any adjustment to the information described herein at any time without notice. Please always obtain the most recent version of the datasheet which shall be duly incorporated into the binding contract made by the parties governing all transactions related to the purchase and sale of the products described herein.

Caution: For professional use only. The installation and handling of PV modules requires professional skills and should only be performed by qualified professionals. Please read the safety and installation instructions before using the modules.

CS6K-295MS / I-V CURVES

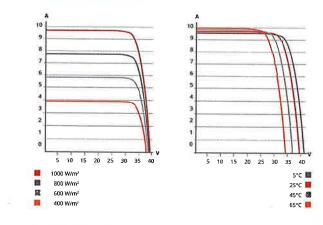


MECHANICAL DATA

Specification	Data
Cell Type	Mono-crystalline, 6 inch
Cell Arrangement	60 (6 x 10)
Dimensions	1650 x 992 x 40 mm (65.0 x 39.1 x 1.57 in)
Weight	18.2 kg (40.1 lbs)
Front Cover	3.2 mm tempered glass
Frame Material	Anodized aluminium alloy
J-Box	IP67, 3 diodes
Cable	4 mm ² (IEC) or 4 mm ² & 12 AWG
	1000 V (UL), 1000 mm (39.4 in)
Connector	T4 (IEC/UL)
Per Pallet	26 pieces, 520 kg (1146.4 lbs)
Per Container (40' HQ)	

TEMPERATURE CHARACTERISTICS

Data
-0.39 % / °C
-0.30 % / °C
0.053 % / °C
45±2 °C

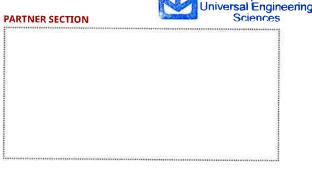

CANADIAN SOLAR (USA), INC. January 2017. All rights reserved, PV Module Product Datasheet V5.531P1_NA

Castillo (Engineering 🕓

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FAFCO® and SolarWorld® combine their industry leading

technology to produce the world's best performing Enhanced Solar Electric and Solar Water Heating System



Enhanced Solar Electric and Solar Water Heating System

CoolPV® Benefits



Annual Energy Production (Kwh)

443

749

Final CoolPV*
Output Reflects
10% Enhanced PV
Production

Cool PV®

SFRFCO*

www.CoolPVSolar.com

Thermal Specifications

Heat Output	1 kW	3400 btu/hr
Operating Pressure	-35/+35 kPa	-5/+5 psi
Test Pressure	345 kPa	50 psi
Flow Rate (Typical)	5.68 lpm	1.5 gpm


Mechanical Specifications

Panel Dimensions	1.00 x 1.68 m	39.4 x 66.1 in
Panel Area	1.68 m2	18.1 ft ²
Roof Load (dry)	15.1 kg/m2	3.1 psf
Fluid Capacity	3.2 L	0.84 gal
Fluid Connection Type	FAFCO I	Proprietary
Electrical Connection Type	Per UL4703 with	H4/UTX connectors



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CoolPV Example Day

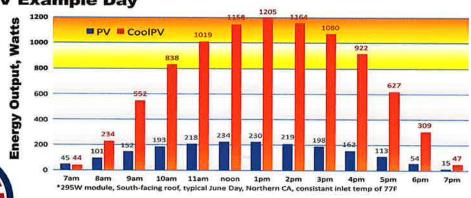

SFRFCO° Www.CoolPVSolar.com

P/N 09629 Rev: C 8/18

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DATE	DESCRIPTION
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SHEET NAME

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ANSI B 11" X 17"

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Data Sheet **Enphase Microinverters** Region: US

Enphase IQ 7 and IQ 7+ **Microinverters**

The high-powered smart grid-ready Enphase IQ 7 Micro™ and Enphase IQ 7+ Micro™ dramatically simplify the installation process while achieving the highest system efficiency.

Part of the Enphase IQ System, the IQ 7 and IQ 7+ Microinverters integrate seamlessly with the Enphase IQ Envoy™, Enphase Q Aggregator™, Enphase IQ Battery™, and the Enphase Enlighten™ monitoring and analysis software.

IQ Series Microinverters extend the reliability standards set forth by previous generations and undergo over a million hours of power-on testing, enabling Enphase to provide an industry-leading warranty of up to 25 years.



Easy to Install

- Lightweight and simple
- · Faster installation with improved, lighter two-wire cabling
- Built-in rapid shutdown compliant (NEC 2014 & 2017)

Productive and Reliable

- · Optimized for high powered 60-cell and 72-cell* modules
- · More than a million hours of testing
- · Class II double-insulated enclosure
- UL listed

Smart Grid Ready

- · Complies with advanced grid support, voltage and frequency ride-through requirements
- · Remotely updates to respond to changing
- · Configurable for varying grid profiles
- Meets CA Rule 21 (UL 1741-SA)
- * The IQ 7+ Micro is required to support 72-cell modules...



To learn more about Enphase offerings, visit enphase.com



Enphase IQ 7 and IQ 7+ Microinverters

INPUT DATA (DC)	IQ7-60-2-US		IQ7PLUS-72-	2-US
Commonly used module pairings¹	235 W - 350 W +		235 W - 440 W	/ +
Module compatibility	60-cell PV modu	ules only	60-cell and 72	-cell PV modules
Maximum input DC voltage	48 V		60 V	
Peak power tracking voltage	27 V - 37 V		27 V - 45 V	
Operating range	16 V - 48 V		16 V - 60 V	
Min/Max start voltage	22 V / 48 V		22 V / 60 V	
Max DC short circuit current (module Isc)	15 A		15 A	
Overvoltage class DC port	II		II	
DC port backfeed current	0 A		0 A	
PV array configuration			tional DC side prote 20A per branch circ	
OUTPUT DATA (AC)	IQ 7 Microinve	rter	IQ 7+ Microi	nverter
Peak output power	250 VA		295 VA	
Maximum continuous output power	240 VA		290 VA	
Nominal (L-L) voltage/range²	240 V / 211-264 V	208 V / 183-229 V	240 V / 211-264 V	208 V / 183-229 V
Maximum continuous output current	1.0 A	1.15 A	1.21 A	1.39 A
Nominal frequency	60 Hz		60 Hz	
Extended frequency range	47 - 68 Hz		47 - 68 Hz	
AC short circuit fault current over 3 cycles	5.8 Arms		5.8 Arms	
Maximum units per 20 A (L-L) branch circuit ^a	16 (240 VAC) 13 (208 VAC)		13 (240 VAC) 11 (208 VAC)	
Overvoltage class AC port	ııı '		III	
AC port backfeed current	0 A		0 A	
Power factor setting	1.0		1.0	
Power factor (adjustable)	0.7 leading 0.7	7 lagging	0.7 leading () 7 Jagging
EFFICIENCY	@240 V	@208 V	@240 V	@208 V
Peak CEC efficiency	97.6 %	97.6 %	97.5 %	97.3 %
CEC weighted efficiency	97.0 %	97.0 %	97.0 %	97.0 %
MECHANICAL DATA	IQ 7 Microinve	rter		
Ambient temperature range	-40°C to +65°C			
Relative humidity range	4% to 100% (con	densina)		
Connector type		٠,	additional Q-DCC-5	adapter)
Dimensions (WxHxD)	212 mm x 175 m			daptery
Weight	1.08 kg (2.38 lbs	,		
Cooling	Natural convecti	•		
Approved for wet locations	Yes	,,,,,,,,,,,,,,,,,,,,,,,,,,,,,,,,,,,		
Pollution degree	PD3			
Enclosure		neulated corros	ion resistant polym	aria analogura
Environmental category / UV exposure rating	NEMA Type 6 / c		ion resistant polyin	eric ericiosare
FEATURES	TVLIVIA Type 07 C	414001		
Communication	Power Line Com	munication (DLC	1	
Monitoring	Power Line Communication (PLC) Enlighten Manager and MyEnlighten monitoring options. Both options require installation of an Enphase IO Envoy.			
Disconnecting means	The AC and DC connectors have been evaluated and approved by UL for use as the load-break disconnect required by NEC 690.			
Compliance	CA Rule 21 (UL 1 UL 62109-1, UL1 CAN/CSA-C22.2 This product is U	741-SA) 741/IEEE1547, F(NO. 107.1-01 JL Listed as PV F	CC Part 15 Class B, Rapid Shut Down Eq	ICES-0003 Class B, uipment and conforms with NEC-2014 and 8 Rapid Shutdown of PV Systems, for AC

and DC conductors, when installed according manufacturer's instructions.

- No enforced DC/AC ratio. See the compatibility calculator at https://enphase.com/en-us/support/module-compatibility.
 Nominal voltage range can be extended beyond nominal if required by the utility.
 Limits may vary. Refer to local requirements to define the number of microinverters per branch in your area.

To learn more about Enphase offerings, visit enphase.com

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SHEET NAME

DATA SHEET

SHEET SIZE

ANSI B 11" X 17"


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Data Sheet **Enphase Networking**

Enphase IQ Combiner 3

(X-IQ-AM1-240-3)

The **Enphase IQ Combiner 3**™ with Enphase IQ Envoy™ consolidates interconnection equipment into a single enclosure and streamlines PV and storage installations by providing a consistent, pre-wired solution for residential applications. It offers up to four 2-pole input circuits and Eaton BR series busbar assembly.

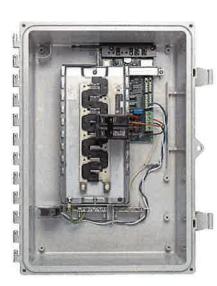

Smart

- · Includes IQ Envoy for communication
- · Flexible networking supports Wi-Fi, Ethernet, or cellular
- · Optional AC receptacle available for PLC bridge
- · Provides production metering and optional consumption monitoring

Simple

- · Reduced size from previous combiner
- · Centered mounting brackets support single stud mounting
- · Supports back and side conduit entry
- Up to four 2-pole branch circuits for 240 VAC plug-in breakers (not included)
- · 80 A total PV or storage branch circuits

Reliable

- · Durable NRTL-certified NEMA type 3R enclosure
- · Five-year warranty
- UL listed



Enphase IQ Combiner 3

MODEL NUMBER	(0.550-0.50) 1 - 0.5 2.5 0.5 1.5
IQ Combiner 3 X-IQ-AM1-240-3	IQ Combiner 3 with Enphase IQ Envoy™ printed circuit board for integrated revenue grade PV production metering (ANSI C12.20 +/- 0.5%) and optional* consumption monitoring (+/- 2.5%)
ACCESSORIES and REPLACEMENT PARTS (n-	ot included, order separately)
Enphase Mobile Connect™ CELLMODEM-03 (4G / 12-year data plan) CELLMODEM-01 (3G / 5-year data plan) CELLMODEM-M1 (4G based LTE-M / 5-year data plan)	Plug and play industrial grade cellular modem with data plan for systems up to 60 microinverters. (Available in the US, Canada, Mexico, Puerto Rico, and the US Virgin Islands, where there is adequate cellular service in the installation area.)
Consumption Monitoring* CT CT-200-SPLIT	Split core current transformers enable whole home consumption metering (+/- 2.5%).
Circuit Breakers BRK-10A-2-240 BRK-15A-2-240 BRK-20A-2P-240	Supports Eaton BR210, BR215, BR220, BR230, BR240, BR250, and BR260 circuit breakers. Circuit breaker, 2 pole, 10A, Eaton BR210 Circuit breaker, 2 pole, 15A, Eaton BR215 Circuit breaker, 2 pole, 20A, Eaton BR220
EPLC-01	Power line carrier (communication bridge pair), quantity 2
XA-PLUG-120-3	Accessory receptacle for Power Line Carrier in IQ Combiner 3 (required for EPLC-01)
XA-ENV-PCBA-3	Replacement IQ Envoy printed circuit board (PCB) for Combiner 3
ELECTRICAL SPECIFICATIONS	
Rating	Continuous duty
System voltage	120/240 VAC, 60 Hz
Eaton BR series busbar rating	125 A
Max. continuous current rating (output to grid)	65 A
Max. fuse/circuit rating (output)	90 A
Branch circuits (solar and/or storage)	Up to four 2-pole Eaton BR series Distributed Generation (DG) breakers only (not included)
Max. continuous current rating (input from PV)	64 A
Max. total branch circuit breaker rating (input)	80A of distributed generation / 90A with IQ Envoy breaker included
Production Metering CT	200 A solid core pre-installed and wired to IQ Envoy
MECHANICAL DATA	
Dimensions (WxHxD)	49.5 x 37.5 x 16.8 cm (19.5" x 14.75" x 6.63"). Height is 21.06" (53.5 cm with mounting bracket
Weight	7.5 kg (16.5 lbs)
Ambient temperature range	-40° C to +46° C (-40° to 115° F)
Cooling	Natural convection, plus heat shield
Enclosure environmental rating	Outdoor, NRTL-certified, NEMA type 3R, polycarbonate construction
Wire sizes	20 A to 50 A breaker inputs: 14 to 4 AWG copper conductors 60 A breaker branch input: 4 to 1/0 AWG copper conductors Main lug combined output: 10 to 2/0 AWG copper conductors Neutral and ground: 14 to 1/0 copper conductors Always follow local code requirements for conductor sizing.
Altitude	To 2000 meters (6,560 feet)
INTERNET CONNECTION OPTIONS	
Integrated Wi-Fi	802.11b/g/n
Ethernet	Optional, 802.3, Cat5E (or Cat 6) UTP Ethernet cable (not included)
Cellular	Optional, CELLMODEM-01 (3G) or CELLMODEM-03 (4G) or CELLMODEM-M1 (4G based LTE-M (not included)
COMPLIANCE	· · · · · · · · · · · · · · · · · · ·
Compliance, Combiner	UL 1741 CAN/CSA C22.2 No. 107.1 47 CFR, Part 15, Class B, ICES 003 Production metering: ANSI C12.20 accuracy class 0.5 (PV production)
Compliance, IQ Envoy	UL 60601-1/CANCSA 22:2 No. 61010-1

To learn more about Enphase offerings, visit enphase.com

* Consumption monitoring is required for Enphase Storage Systems.

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DS-04



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Built for solar's toughest roofs.

IronRidge builds the strongest roof mounting system in solar. Every component has been tested to the limit and proven in extreme environments.

Our rigorous approach has led to unique structural features, such as curved rails and reinforced flashings, and is also why our products are fully certified, code compliant and backed by a 20-year warranty.



Strength Tested

All components evaluated for superior structural performance.



PE Certified

Pre-stamped engineering letters available in most states.



Class A Fire Rating

Certified to maintain the fire resistance rating of the existing roof.



Design Software

Online tool generates a complete bill of materials in minutes.



Integrated Grounding

UL 2703 system eliminates separate module grounding components.



20 Year Warranty

Twice the protection offered by competitors.

XR Rails 🖶 -XR10 Rail

XR100 Rail



The ultimate residential solar mounting rail.

- · 8' spanning capability
- · Heavy load capability
- · Clear and black finish

XR1000 Rail

- A heavyweight mounting rail for commercial projects.
- · 12' spanning capability Extreme load capability
- · Clear anodized finish

Bonded Splices



All rails use internal splices for seamless connections.

- · Self-drilling screws
- · Varying versions for rails
- · Forms secure bonding

Clamps & Grounding (#)

A low-profile mounting rail

for regions with light snow.

· Moderate load capability

6' spanning capability

· Clear and black finish

UFOs



Universal Fastening Objects bond modules to rails.

- Fully assembled & lubed
- · Single, universal size
- · Clear and black finish

Stopper Sleeves



Snap onto the UFO to turn into a bonded end clamp.

- · Bonds modules to rails
- · Sized to match modules
- · Clear and black finish

Grounding Lugs



Connect arrays to equipment ground.

- Low profile
- · Single tool installation
- · Mounts in any direction

Bonding Hardware

Microinverter Kits



Mount MIs or POs to XR

- · Bonds devices to rails · Kit comes assembled
- Listed to UL 2703

Flush Standoffs

Attachments (#)

FlashFoot2



Flash and mount XR Rails with superior waterproofing.

- · Twist-on Cap eases install
- · Wind-driven rain tested
- · Mill and black finish

Resources -

Slotted L-Feet

attachment.

- Secure rail connections
- · Slot for vertical adjusting
- · Clear and black finish
- Drop-in design for rapid rail Bond and attach XR Rails to roof attachments.

 - · Nut uses 7/16" socket
 - Assembled and lubricated
 - Raise Flush Mount System to various heights. · T & Square Bolt options · Works with vent flashing

 - 4" and 7" lengths
 - · Ships assembled



Design Assistant

Go from rough layout to fully engineered system. For free. Go to IronRidge.com/design



NABCEP Certified Training

Earn free continuing education credits. while learning more about our systems. Go to IronRidge.com/training

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SolarRoofHook has the most innovative line of Asphalt Shingle Roof Mounts in the industry.

Our QuickBOLT with Microflashing $^{\text{TM}}$ is the future of Asphalt Shingle Roof solar mounting. Use the QuickBOLT to save time and money by installing faster, eliminating the need for bulky aluminum flashing, and completing more residential jobs. The installers' liability is also reduced, as Microflashing™ can be installed directly over the shingles and does not require the removal of any nails. Try the QuickBOLT with Microflashing™ today.

We also carry a line of Flashed L-Foot and U-Foot products.



AVAILABLE ONLINE:







Specs & Test



AZ Test Results



Racking Compatibility



Installation Instructions



Videos

LOW PROFILE QUICKBOLT





3" Microflashing™ Low Profile

PN#	BOX QTY
17664	5.25" Bolts (10)
17666	Bolts + 3" Microflashing™ (10ea.)
17667SS	Bolts + 3" Microflashing™ + SS L-Foot + Nuts (10ea.)

First & only Microflashing™ in the industry Stainless Steel L-Foot Fastest installation in the industry **UL** Certified



OW PROFILE QUICKBOLT





PN#	BOX QTY
17664	5.25" Bolis (10)
17720	Bolts + 4" Microflashing™ (10ea.)
17721 SS	Bolts + 4" Microflashing TM + SS L-Foot + Nuts (10ea.)

First & only Microflashing™ in the industry Stainless Steel L-Foot 4" Microflashing™ provides more coverage Fastest installation in the industry **UL** Certified



QUICKBOLT





PN#	BOX QTY
17670	7" Bolts (10)
17671	Bolts + 3" Microflashing™ (10ea.)
17672SS	Bolts (10) + 3" Microflashing™ (10) + SS L-Foot (10) + Nuts (20)

First & only Microflashing™ in the industry Stainless Steel L-Foot **UL** Certified







PN#	BOX QTY
17670	7" Bolts (10)
17723	Bolts + 4" Microflashing™ (10ea.)
17724SS	Bolts (10) + 4" Microflashing™ (10) + SS L-Foot (10) + Nuts (20)

First & only Microflashing™ in the industry Stainless Steel L-Foot 4 $^{\text{TM}}$ Microflashing $^{\text{TM}}$ provides more coverage **UL** Certified

Reviewed for Code Compliance

ANSIB 11" X 17"

SHEET NAME

DATA SHEET

SHEET SIZE

WOODS RESIDENCE

3042 HOFFNER A BELLE ISLE, FL 3;

Castillo (Engineering 6 DESIGNED TO PERMIT CASTILLO ENGINEERING SERVICES, LLC COA # 28345 2925 W. STATE ROAD 434, SUITE 111 LONGWOOD, FL 32779

TEL: (407) 289-2575 ERMOCRATES E, CASTILLO - FL PE 52590

REVISIONS

PROJECT INSTALLER

DATE

DESCRIPTION

SHEET NUMBER