### City of Belle Isle Job Site Card Window/Door PERMIT 2019-04-009

PERMITT MUST BE POSTED ON SITE - A permit expires in 6 months if approved inspections are not ecorded /schedule within that time frame. You are responsible for scheduling and keeping track of all inspections.

**Permit Number:** 2019-04-009 **Site Address:** 5261 Hawford Cir

**Issue Date**: 04/03/2019 32812 **Parcel** #: 20-23-30-9375-00-180

**Class**: □ Residential

Subdivision:

**Description of Work**: 3 DOORS/ Size for Size

Issued: NEWSOUTH WINDOW SOLUTIONS, LLC
Name: OCHSTEIN, SAMUEL ELI
Business Phone: 407 261-2277
Contractor License: CRC1330822

Schedule Inspections via Email at: <u>BIDscheduling@universalengineering.com</u>
SCHEDULE INSPECTIONS BY 3:00 PM CUT OFF TIME
Inspection Results Will Be Sent Out the Following Business Day

"WARNING TO OWNER: YOUR FAILURE TO RECORD A NOTICE OF COMMENCEMENT MAY RESULT IN YOUR PAYING TWICE FOR IMPROVEMENTS TO YOUR PROPERTY. IF YOU INTEND TO OBTAIN FINANCING, CONSULT WITH YOUR LENDER OR AN ATTORNEY BEFORE RECORDING YOUR NOTICE OF COMMENCEMENT."

BUILDING	INSPECTOR	DATE	COMMENTS
900 In Progress			
910 Final			

Inspection requests are to be emailed to <a href="mailto:BIDscheduling@UniversalEngineering.com">BIDscheduling@UniversalEngineering.com</a>; a confirmation email will be sent back to you upon scheduling. <a href="Mext-Day Inspection requests must be made by 3pm">Next-Day Inspection requests must be made by 3pm</a>. Please include the following in your request: Permit #, project address, type of inspection, date of the requested inspection, a contact name & a contact phone number. AM or PM may be requested but cannot be guaranteed. Inspection results will be sent out the following business day. A permit expires in 6 months if approved inspections are not recorded /scheduled within that time frame. You are responsible for scheduling and keeping track of all your inspections —

Universal Engineering Sciences - 3532 Maggie Blvd., Orlando, FL 32811 Tel 407-581-8161 \* Fax 407-581-0313 \* www.universalengineering.com



### City of Belle Isle

Universal Engineering Sciences 3532 Maggie Blvd., Orlando, FL 32811 Tel 407-581-8161 \* Fax 407-581-0313 \* www.universalengineering.com

### APPLICATION FOR SIZE-FOR-SIZE WINDOW / DOOR PERMIT

WARNING TO OWNER: YOUR FAILURE TO RECORD A NOTICE OF COMMENCEMENT MAY RESULT IN YOUR PAYING TWICE FOR IMPROVEMENTS TO YOUR PROPERTY. A NOTICE OF COMMENCEMENT MUST BE RECORDED AND POSTED ON THE JOB SITE BEFORE THE FIRST INSPECTION. IF YOU INTEND TO OBTAIN FINANCING, CONSULT WITH YOUR LENDER OR AN ATTORNEY REFORE RECORDING YOUR NOTICE OF COMMENCEMENT.

ATTORNEY BEFORE RECORDING YOUR NOTICE OF COMMENCEMENT.	
DATE OF APPLICATION: PERMIT	NUMBER 2019-04-009
PLEASE PRINT. The undersigned hereby applies for a permit to make installations as ind	licated below:
Project Address 5261 HAWFORD CIRCLE	, Belle Isle, FL32809X_32812
	Phone 407-729-5800
Property Owner's Mailing Address 5261 HAWFORD CIRCLE	_City_BELLE ISLE
State FL Zip Code 32812 Parcel Id Number: 20-23-30-9375	i-00-180
REQUIRED! To obtain this information, please vis	sit http://www.ocpafl.org/Searches/ParcelSearch.aspx
REQUIREDI Florida Product Approval Form – NOTE: Installation instructions must be pos	ited on-site before your first inspection!!
Please indicate the nature of work by completing the information below:	
Number of Size-for-Size Windows: 0 Number of Size-for-Size Doors: 3	Job Valuation: 7485
I hereby certify that the above is true and correct to the best of my knowledge and make Application for agree to conform to all Florida Building Code Regulations and City Ordinances regulating same and it of this permit does not grant permission to violate any applicable Town and/or State of Florida codes a Republic Services is by legal contract the sole authorized provider of garbage, recycling, yard waste, a collection and disposal services with the city limits of the City. Contractors, homeowners and commerce 407-293-8000 to setup accounts for Commercial, Construction Roll Off, or other services needed. Rat Hall or from Republic Services. The City enforces the contract through its code enforcement office. Fa	n accordance with plans submitted. The issuance ind/or ordinances. By signing below, I recognize and commercial garbage and construction debris it businesses may contact Republic Services at es are fixed by contract and are available at City
BY SIGNING THIS APPLICATION, YOU ARE CERTIFYING THAT YOU ARE ACTIN PERMIT: REQUIRED	
LICENSE HOLDER SIGNATURE	REQUIRED LICENSE # 130822
	NEW SOUTH WINDOW
Street Address 820 E ALTAMONTE DR	
City ALTAMONTE SPRINGS State FL Zip Code 32701	Phone Number 407-261-2277
Email Address_elainelewis@newsouthwindow.com	
woc	Zoning Fee \$
PA	Permit Fee \$ 53.00
Building Official: St Date_ 6/12 - 19	Review Fee \$ 36.50
	1% BCAIB Fee \$
Verified Contractor's Licenses & Insurance are on file Date	1.5% DCA Fee \$ 2 min
	Total Permit Fee \$ \$ 3.5 C



RECEIVED APR 2 - 2019 City of Belle Isle
Universal Engineering Sciences 3532 Maggie Blvd., Orlando, FL 32811
Tel 407-581-8161 \* Fax 407-581-0313 \* www.universalengineering.com

### **Building Permit (Land Use) Application**

<b>5</b> 1 1 1 1 1 1 1 1 1 1 1 1 1 1 1 1 1 1 1	/ · · ·   ·   · · · · · · · · · · · · ·
DATE:	ERMIT # 2019-04-009
PROJECT ADDRESS 5261 Hawford Cir	, Belle Isle, FL3280932812
PROPERTY OWNER Border Gary W & Border Marolyn K PHONE 407-729-5800	ALUE OF WORK (labor &material) \$ 7485
PLEASE LIST THE NATURE OF YOUR PROPOSED IMPROVEMENTS	
REPLACING WINDOWS AND/OR DOORS SIZE FOR SIZE	
Please provide information, if applicable.  • Survey specific foundation plan required to show compliance with zoning setbacks  • BOAT DOCK: DEP Clearance Required with Application (Call 407-897-4100); please provide a SEPTIC SYSTEM (RESIDENTIAL): – Provide verification of OC Health Dept approval for on-s Homeowners will be required to have a contractor on record for homes that are rented and/o	a copy of their report ite septic tank system, per FAC Chap. 64E-6
Please Complete for the City of Belle Isle Zoning Review: Parcel Id Number: 20-23-30-9	375-00-180
	sit http://www.ocpafl.org/Searches/ParcelSearch.aspx
SPECIAL CONDITIONS: STRUCTURES MAY NOT ENCROACH INTO ANY EASEMENT OR	Wind Exposure Category: B C D D
REQUIRED SETBACK. Note, this Zoning Approval MAY or MAY NOT be in conflict with your Deed Restrictions. For New Single Family Residence, a Traffic Impact Fee and School Impact	SPRINKLERS REQ'D Y N
will be assessed.	
Attached SurveySETS and Construction PlansSETS	If Required – SUBMIT COPY OF PLANS FOR FIRE REVIEW Date: SentRCD
DI ANNING & ZONING ADDDOVAL.	10 MILE 1
PLANNING & ZONING APPROVAL:	ZONING Y S S S CERT OF OCC Y N S
DAIL	CERT OF OCC         Y         N         \$           TRAFFIC         Y         N         \$
PLEASE COMPLETE for Building Review	SCHOOL Y N \$
CONSTRUCTION TYPE	
OCCUPANCY GROUPComm Res: Single Fam Multi Fam	
#BLDG,#UNITS _ #STORIES <b>TOTAL SQ.FT.</b>	SWIMMING POOL Y N \$ SCREEN ENCLOSURE Y N \$
MAX. FLOOR LOAD MAX. OCCUPANCY	ROOFING Y N S
MIN. FLOOD ELEVLOW FLOOR ELEV	BOAT DOCK Y N S
WATER SERVICEWELLSEPTIC	BUILDING Y N \$
	WINDOW(S) Y N S
BUILDING REVIEWER	DOOR(S) N S MIS
BUILDING REVIEWERDATE	FENCE y N \$
VERIFIED CONTRACTOR'S LICENSE & INSURANCE ARE ON FILE DATE	SHED Y N \$
	DRIVEWAY Y N \$
Per FSS 105.3.3:	OTHERY N \$
An enforcing authority may not issue a building permit for any building construction, erection, alteration,	2.5
modification, repair or addition unless the permit either includes on its face or there is attached to the	8% FL SURCHARGE
permit the following statement: "NOTICE: In addition to the requirements of this permit, there may be additional restrictions applicable to this property that may be found in the public records of this county,	2+2 92 CD
and there may be additional permits required from other governmental entities such as water	TOTAL
management districts, state agencies, or federal agencies."	
Republic Services is by legal contract the sole authorized provider of garbage, recycling, yard waste,	By Owner Form Y NA Notice of Commencement Y NA
and commercial garbage and construction debris collection and disposal services with the city limits of	Notice of Commencement Y NA Power of Attorney Y NA
the City. Contractors, homeowners and commercial businesses may contact Republic Services at 407-	Contractor Packet Incuded? Y N
293-8000 to setup accounts for Commercial, Construction Roll Off, or other services needed. Rates are fixed by contract and are available at City Hall or from Republic Services. The City enforces the	Contractor racket incuded 1
contract through its code enforcement office. Failure to comply will result in a stop work order.	OTHER PERMITS REQUIRED:
	ELECTRICAL Y NA
SEPARATE PERMITS ARE REQUIRED FOR ROOFING, ELECTRICAL, PLUMBING, GAS,	PREPOWER Y NA
MECHANICAL, SIGNS, POOLS, ENCLOSURES, ETC.	MECHANICAL Y NA
Page 1012 151 14 25 4x7 28	PLUMBING Y NA
11.7 28	ROOFING Y NA
YX I	GAS Y NA
53-2	



### City of Belle Isle

Universal Engineering Sciences 3532 Maggie Blvd., Orlando, FL 32811 Tel 407-581-8161 \* Fax 407-581-0313 \* <a href="https://www.universalengineering.com">www.universalengineering.com</a>

### **Building Permit (Land Use) Application**

To be completed as required by State Statute Section 713 and other applicable sections.

Owner's Name Border Gary W & Border Marolyn K

Owner's Address 5261 Hawford Cir Orlando, FI 32812

PERMIT # 2019-64-009

Contractor Name SAMUEL OCHSTEIN	Company Name NEWSOUTH WINDOW
License # CRC1330822	Company Address 820 E ALTAMONTE DR
Contact Phone/Cell 407-261-2277	City, State, ZIP ALTAMONTE SPRINGS, FL 32701
Contact Email ELAINELEWIS@NEWSOUTHWINDOW.COM	Contact Fax 407-261-2278

WARNING TO OWNER: Your failure to record a Notice of Commencement may result in your paying twice for improvements to your property. A notice of commencement must be recorded if job is \$2500(+) or if A/C Replacement \$7500(+) and posted on the job site before the first inspection. If you intend to obtain financing, consult with your lender or an attorney before recording your Notice of Commencement.

I hereby make Application for Permit as outlined above, and if same is granted I agree to conform to all Division of Building Safety Regulations (<a href="www.floridabuilding.org">www.floridabuilding.org</a>) and City Ordinances (<a href="www.municode.com">www.municode.com</a>) regulating same and in accordance with plans submitted. The issuance of this permit does not grant permission to violate any applicable City and/or State of Florida codes and /or ordinances. Application is hereby made to obtain a permit to do the work and installations as indicated. I certify that no work or installation has commenced prior to the issuance of a permit and that all work will be performed to meet the standards of all laws regulating construction in this jurisdiction. I understand that a <a href="weeparate">separate</a> permit must be secured for all other construction including ROOFING, ELECTRICAL, MECHANICAL, PLUMBING, GAS, SIGNS, POOLS, SCREEN ENCLOSURES, ETC.

OWNER'S AFFIDAVIT: I certify that all the foregoing information is accurate and that all work will be done in compliance with all applicable laws regulating

construction and zoning.	
The foregoing instrument was acknowledged before me this 3 / 7 / 2019  by Any W. Bount who is personally known to me and who produced as identification and who did not take an oath.  Notary as to Owner State of Florida County of Orange  NOTARY PUBLIC STATE OF FLORIDA Comm# GG245436	Impervious Surface Ratio Worksheet  Development Zoned A-1. A-2, R-1-AAA, R-1-AA, R-1-A, R-1 per City Code, Section 50-74: Impervious Surface Ratio  1. Total Lot Area (sqft) X 0.35 = Allowable Impervious Area (BASE).  Total Lot Area
**************************************	Driveway
Contractor Signature	Walkway
COMPANY NAME NEW SOMETH WINDOW	Accessory Buildings
The foregoing instrument was acknowledged before me this 12,19	Pool & Spa
by Muel Och Stain who is personally known to me	Deck & Patio
and who produced	• Other
as identification and who did not take an oath.	Actual Impervious Area (AIA)
Notary as to Owner State of Florida County of Orange  Millie Hawkins NOTARY PUBLIC	If AIA <u>is less than</u> BASE, subtract AIA from BASE to determine the amount of impervious area that may be added without providing onsite retention.
STATE OF FLORIDA Comm# GG245440	4. If AIA is greater than BASE, then onsite retention must be provided.
Expires 8/5/2022	Assuming 7.5 inches of rainfall based on a 24hr 10 year Rain Event (TP40), the formula is: (7.5 inches rainfall/12 inches p/foot) X (result from line 4)

5.55		04/02/2019 12:16 PM Page 1 of 1
_	Prmit Number: 2014-04-609	Rec Fee: \$10,00 Deed Doc Tax: \$0.00
	ermit Number:	Mortgage Doc Tax: \$0.00
	epared by: MILLIE HAWKINS	Intangible Tax: \$0.00 Phil Diamond, Comptroller
_	Main al amic	Orange County, FL
_	E/MIE(EWI)	Ret To: SIMPLIFILE LC
	eturn to: MILLIE HAWKINS 20 E Altamonte Drive,	
	tamonte Springs, FL 32701	
-	NOTICE OF COMMEN	CEMENT
St	ate of Florida, County of Orange	
	e undersigned hereby gives notice that improvement will be ma	
	th Chapter 713, Florida Statutes, the following information is pro <b>Description of property</b> (legal description of the property, and	
١.	WINDSOR PLACE PHASE 2 30/81 LOT 18	I HULLATON OF TWO
2.	General description of improvement	,
_	REPLACING WINDOWS AND/OR DOORS SIZE FOR S	
3.	Owner information or Lessee information If the Lessee cor Name Border Gary W & Border Marolyn K	•
	Address 5261 Hawford Cir Orlando, Fl 32812	
	Interest in Property OWNER	
	Name and address of fee simple titleholder (if different from	n Owner listed above)
	Name	
4	AddressContractor	113-11-11
	Name New South Window	Telephone Number 407-261-2277
	Address 820 E Altamonte Drive, Altamonte Springs, FL 32701	
5.	Surety (if applicable, a copy of the payment bond is attached)	T-A-base No. 1
	Name N/A Address	Telephone Number Amount of Bond \$
6.	Lender	Amount of Bond \$
	Name N/A	Telephone Number
_	Address	
1.	Persons within the State of Florida designated by Owner up be served as provided by §713.13(1)(a)7, Florida Statutes.	
	Name N/A	- · · · · · · · · · · · · · · · · · · ·
	Address	9 1975-2
8.	In addition to himself or herself, Owner designates the fol Notice as provided in §713.13(1)(b), Florida Statutes.	lowing to receive a copy of the Lienor's
	Name N/A	Telephone Number
	Address	
9.	Expiration date of notice of commencement (the expiration	
	construction and final payment to the contractor, but will be 1 y	year from the date of recording unless a
	different date is specified)	
	RNING TO OWNER: ANY PAYMENTS MADE BY THE OWNER AFTER THE	
	E CONSIDERED IMPROPER PAYMENTS UNDER CHAPTER 713, PART I, S SULT IN YOUR PAYING TWICE FOR IMPROVEMENTS TO YOUR PROPERT	
RE	CORDED AND POSTED ON THE JOB SITE BEFORE THE FIRST INSPECTI	ON. IF YOU INTEND TO OBTAIN FINANCING, CONSULT
WI	IH YOUR LENDER OR AN ATTORNEY BEFORE COMMENCING WORK OR	RECORDING YOUR NOTICE OF COMMENCEMENT.
	der penalty of perjury, I declare that I have read the foregoi	
fac	ts stated in it are true to the best of my knowledge and beli	ief.
5	Danala Devolon / Marsin Vander	
Sig	nature of Owner of Lessee, or Owner's or Lessee's Authorized Officer/Director/	Partner/Manager Signatory's Title/Office
		1 111
Th	e foregoing instrument was acknowledged before me this $\underline{I}^{\mathfrak{H}}$ (	morth/year hame of person By July
as	for	monutyear statue of person
	Type of authority, e.g., officer trustee, attorney in fact Nan	ne of party on behalf of whom instrument was executed
	J 4 7 7 1000	Olga tagara
	Signature of Notary Public - State of Florida Prin	it, type, or stamp commissioned name of Notary Public
P۰	rsonally Known OR Produced ID	CLGA Z 1970. Actary Public - Sixus of Huirda P
	pe of ID Produced # L	Commission # FF 248008
,	A William	My Comra. Expires Jun 23, 2019 Form Revised: September 26, 2011
	Appropriate the second of the	responsible and acceptant in a Disagnation of the Control of the C

DOC # 20190197996



820 E. Altamonte Springs Dr. Altamonte Springs, FL, 32701

Phone: (407) 261-2277 Fax: (407) 261-2278

Contact Email: milliehawkins@newsouthwindow.com

To Whom It May Concern:

I, Samuel Ochstein, hereby authorize the following named person (s) to sign my name on my behalf to apply for and purchase permits for New South Window Solutions of Orlando.

This list is to replace all others previously issued, which are now to be considered null and void.

TYLER LEE FRED BROWN JUSTIN SHAW ELAINE LEWIS

Job Address: 5261 HAWFORD CIRCLE BELLE ISLE, FL 32812

Sincerely,

Samuel Ochstein CRC1330822

State of Florida, County of

This foregoing instrument was acknowledged before me this \_\_\_ day of \_\_\_\_\_\_

Samuel Eli Ochstein, who is personally known to me and did not take an oath.

2019, by

MILLIE HAWKINS
Print name

Millie Hawkins
NOTARY PUBLIC
STATE OF FLORIDA
Comm# GG245440
Expires 8/5/2022

Notary Signature and seal

		News Mindow	out	Notes:				(	L	ئا ئ	Baci	Tool of	II.		1	J	)
Purs	Window Spontact	ecification with NewSouth	and Det	tail										-	_		
Cust	lomer: Bote	er, buy	+ 1	icrolyn								loor					
	1008: 52C									CB 9	ve	<b>10</b>					
	Bille				ZID 32812												
Phor	10: (H)407 - 2	10-4686	(C)		(W)												
Cont	ract Date 0	111/15	Factory	Bep July			Frame	1000		Insulate	Front		_		622	8-6	
Cuet	omer Approval	Dan		Borles			rianes	) Scre	Selis	Insulate	g Gila	SS O	25		Grid	Opti	Oris:
WIN	Location	Style	Color EXT/INT	(W + H) Sales Measure	(W x H) Opening Size	(W x H) Make Size	801	H	3	Glass Type	mgad	parose	4		Ī	Open	100
-1	k.f.	fi-ty to	0	214 x 618	312 × 80至	2.6" × 68"	30	SU	B	LHOS			7	V			
2	Liv	Farterdo	are	610 x 618	1001 ×80%					RHOS			7	V			_
3	L. L.	Selle	414	12" x 618	*80T	12" x 6'8"			120	05			7	1		54	te
4	Lu	3. delik	with	12" × 618	× 80%	12" x 6'8'				os			7	×	_	51:	
5	Astr.	Frank de	up	610 ×618	73½×80%	6' x 6'8"				RHOS			7	2			
6				×	×	×				14/0-							
7				¥											- 1		$\neg$



**Applicant Signature** 

### City of Belle Isle

Universal Engineering Sciences 3532 Maggie Blvd., Orlando, FL 32811 Tel 407-581-8161 \* Fax 407-581-0313 \* www.universalengineering.com

### **Product Approval Form**

DATE: 4/2/19	PERMIT #
PROJECT ADDRESS 5281 HAWFORD CIRCLE BELLE ISLE, FL 32812	Belle Isle, FL32809X_32812

As required by Florida Statue 553.842 and Florida Administrative Code 9B-72m, please provide the information and approval numbers of the building components listed below if they will be utilized on the building or structure. FL Approved products are listed online at <a href="https://www.floridabuilding.org">www.floridabuilding.org</a> or can be obtained from the local product supplier. The following information must be turned in with permit application and available onsite for inspections:

- 1. This Product Approval Cover Sheet
- 2. Internet screen from FloridaBuilding.org showing PA#, approval and code edition stamped
- 3. Manufacturer's installation details from FloridaBuilding.org and requirements for each product stamped

Product Type	<u>Manufacturer</u>	Model/Series	FL Product Approval #	Product Type	Manufacturer	Model/Series	FL Product Approval #
	EXTERIOR I	OORS	111111111111111111111111111111111111111	3 50	WALL PAI	NELS	Description.
Swinging				Sliding			
Sliding	MILLWORKS	ENTRY	17347.1	Soffits			
Sectional/Rollup				Storefront			
Other	MILLWORKS	FRENCH	17347.2	Glass Block			
				Other			
	WINDO	VS			ROOFING PRO	DUCTS	
Single/Dbl Hung				Asphalt Shingles			
Horizontal Slider				Non Struct Metal			
Casement				Roofing Tiles			
Fixed				Single Ply Roof			
Mullion				Underlayment			
Skylights				Other			
Other							
	STRUCTURAL CON	MPONENTS		5.75 (87)	OTHER		
<b>Wood Connectors</b>							
Wood Anchors							
Truss Plates							
Insulation Forms							
Lintels							
Other							

It is the applicant's responsibility to verify that specific products h	ave been installed in accordance with their limitations and
with the minimum required design pressures for the structure. S	pecific compliance will be verified during field inspections.
Silling St	1/2/

### INCORRECT PRODUCT APPROVAL SHEET

Date://	Orange County Product Approval Cover Sheet Permit #
ORANGE	As required by Florida Statute 553.842 and Florida Administrative Code 9B-72m, please provide the information and approval numbers for the building components listed below if they will be utilized on the building or structure.
	Approved product information is listed online or can be obtained from the local product supplier.  FL Product Approval: <a href="https://www.floridabuilding.org">www.floridabuilding.org</a>
TT	Miami Dade Notice of Acceptance: http://www.miamidade.gov/building/home.asp

The following information shall be submitted for plan review and permitting:

- Completed/filled out copies of this Product Approval Cover Sheet. (Residential 2, Commercial 3)
- Copies of the Internet screen shot showing the product and ONLY the product to be installed, its FL Product Approval or Miami Dade NOA number, and the Florida Building Code edition. (Residential 2, Commercial 3) 2)

Product Type	Manufacturer	Model #/Series	FL Product Approval #	Miami Dade NOA#
Exterior Doors				
Swinging				
Sliding	MILLWORKS	ENTRY	17347.1	
Sectional/Rollup				
Other	MILLWORKS	FRENCH	17347.2	
Windows				
Single/Double Hung				
Horizontal Slider				
Casement				
Fixed				
Mullion				
Skylights				
Other				
Wall Panels	*			
Siding				
Soffits				
Storefront				
Glass Block				
Other				
Roofing Products				
Asphalt Shingles		Y		
Single Ply Roof				
Roofing Tiles				
Non Structural Metal				
Other				
Structural Components			,	
Lintels				
Insulation Forms				
Other				

Failure to post the information below on the jobsite, or including items not used, will result in failed inspections.

- One completed/filled out copy of this Product Approval Cover Sheet with OCDBS official approval stamp.
- 2) One copy of Internet screen shot showing the product, its FBC or NOA #, and the FBC Edition with OCDBS official approval stamp.
  - One copy of the manufacturer's installation details and instructions for ONLY the product to be installed

It is the applicant's responsibility to verify specific products have been installed in accordance with their limitations and with the minimum required design pressures for the structure. Specific compliance will be verified during field inspections.

Applicant's Printed Name:	Applicant's Signature:
Rev. 03/27/14	

## **Business & Professional Regulation**





Product Approval Menu > Product or Application Search > Application List > Application Detail

Application Type Revision Code Version 2017 Application Status Approved

Comments Archived

Product Manufacturer

Address/Phone/Email

Authorized Signature

Technical Representative Address/Phone/Email

Quality Assurance Representative

Category

Subcategory

Compliance Method

Address/Phone/Email

Florida Engineer or Architect Name who developed

Referenced Standard and Year (of Standard)

the Evaluation Report Florida License

Quality Assurance Entity

Quality Assurance Contract Expiration Date

Validated By

Certified By

Certificate of Independence

Equivalence of Product Standards

FL17347-R2

Plastpro Inc. / Nanya Plastics Corp.

5200 W CENTURY BLVD. LOS ANGELES, CA 90045 (440) 969-9773 Ext 16 rickw@rwbldgconsultants.com

Vivian Wright

Scott Johnson

rickw@rwbldgconsultants.com

5200 W Century Blvd. Los Angeles, CA 90045 (440) 969-9773 Ext 18

scottjohnson@plastproinc.com

**Exterior Doors** 

Swinging Exterior Door Assemblies

Evaluation Report from a Florida Registered Architect or a Licensed

Florida Professional Engineer

Evaluation Report - Hardcopy Received

Lyndon F. Schmidt, P.E.

PF-43409

National Accreditation and Management Institute

12/31/2019 Ryan J. King, P.E.

✓ Validation Checklist - Hardcopy Received

FL17347 R2 COI (a) Certificate of Independence.pdf

**Standard Year** 101/I.S.2/NAFS 2002 AAMA/WDMA/CSA101/I.S.2/A440 2008 **ASTM E1886** 2002

**ASTM E1996** 2002 ASTM E330 2002 ASTM E331 2000 TAS 201, 202, 203 1994

Florida Licensed Professional Engineer or Architect FL17347 R2 Equiv (b) Equivalency Of Standards.pdf Sections from the Code

Product Approval N	Method	Method 1	Option D

Date Submitted 08/13/2017 Date Validated 09/26/2017 Date Pending FBC Approval 09/29/2017 Date Approved 12/12/2017

### Summary of Products

FL#	Model, Number or Name	Description			
17347.1	a. Fiberglass Door	"Non-Impact" Fiberglass Glazed Door - Single with or without Sidelites (X, OX or XO, OXO) Outswing/Inswing Configurations up to Nominal 6'8 in Height			
Impact Resista Design Pressur Other: See INST	se outside HVHZ: Yes nt: No	Installation Instructions FL17347 R2 II (b) Inst 17347.1.pdf Verified By: Lyndon F. Schmidt, P.E. 43409 Created by Independent Third Party: Yes Evaluation Reports FL17347 R2 AE (b) Eval 17347.1.pdf Created by Independent Third Party: Yes			
17347.2	b. Fiberglass Door	"Non-Impact" Fiberglass Glazed Door - Double with or without Sidelites (XX or OXXO) Outswing/Inswing Configurations up to Nominal 6'8 in Height			
Impact Resista Design Pressur Other: See INST	se outside HVHZ: Yes nt: No	Installation Instructions FL17347 R2 II (b) Inst 17347.2.pdf Verified By: Lyndon F. Schmidt, P.E. 43409 Created by Independent Third Party: Yes Evaluation Reports FL17347 R2 AE (b) Eval 17347.2.pdf Created by Independent Third Party: Yes			
17347.3	c. Fiberglass Door	"Non-Impact" Fiberglass Glazed Door - Single with or with Sidelites (X, OX or XO, OXO) Outswing/Inswing Configurations up to Nominal 8'0 in Height			
Impact Resistant Design Pressure Other: See INST	se outside HVHZ: Yes nt: No	Installation Instructions FL17347 R2 II (b) Inst 17347.3.pdf Verified By: Lyndon F. Schmidt, P.E. 43409 Created by Independent Third Party: Yes Evaluation Reports FL17347 R2 AE (b) Eval 17347.3.pdf Created by Independent Third Party: Yes			
17347.4	d. Fiberglass Door	"Non-Impact" Fiberglass Glazed Door - Double with or without Sidelites (XX or OXXO) Outswing/Inswing Configurations up to Nominal 8'0 in Height			
Impact Resistar Design Pressure Other: See INST	se outside HVHZ: Yes nt: No	Installation Instructions FL17347 R2 II (b) Inst 17347.4.pdf Verified By: Lyndon F. Schmidt, P.E. 43409 Created by Independent Third Party: Yes Evaluation Reports FL17347 R2 AE (b) Eval 17347.4.pdf Created by Independent Third Party: Yes			
17347.5	e. Fiberglass Door	"Impact" Fiberglass Glazed Door - Single with or without Sidelites (X, OX or XO, OXO) Outswing/Inswing Configurations up to Nominal 6'8 in Height			
Impact Resistar Design Pressure Other: See INST	se outside HVHZ: Yes nt: Yes	Installation Instructions FL17347 R2 II (b) Inst 17347.5.pdf Verified By: Lyndon F. Schmidt, P.E. 43409 Created by Independent Third Party: Yes Evaluation Reports FL17347 R2 AE (b) Eval 17347.5.pdf Created by Independent Third Party: Yes			
17347.6	f. Fiberglass Door	"Impact" Fiberglass Glazed Door - Double with or without Sidelites (XX or OXXO) Outswing/Inswing Configurations up to Nominal 6'8 in Height			
Limits of Use Approved for us	e in HVHZ: No	Installation Instructions FL17347 R2 II (b) Inst 17347.6.pdf			



# plastpro


5200 W. CENTURY BLVD. LOS ANGELES, CA 90045


### GLAZED FIBERGLASS DOORS SINGLES w/ or w/o SIDELITES **INSWING / OUTSWING** "NON-IMPACT"

### **GENERAL NOTES**


- 1. This product has been evaluated and is in compliance with the 6th Edition (2017) Florida Building Code (FBC) structural requirements excluding the "High Velocity Hurricane Zone" (HVHZ).
- 2. Product anchors shall be as listed and spaced as shown on details. Anchor embedment to base material shall be beyond wall dressing or stucco.
- 3. When used in areas requiring wind borne debris protection, this product is required to be protected with an impact resistant covering that complies with FBC Sections 1609.1.2 & R301.2.1.2.
- 4. For 2x stud framing construction, anchoring of these units shall be the same as that shown for 2x buck masonry construction.
- Site conditions that deviate from the details of this drawing require further engineering analysis by a licensed engineer or registered architect.

	TABLE OF CONTENTS				
SHEET#	SHEET# DESCRIPTION				
1	Typical elevations, design pressures & general notes				
2	Door & Sidelite panel details				
3	Lite frame glazing details				
4	Elevations				
5	Horizontal cross sections				
6	Horizontal & Vertical Cross Sections (2X Buck)				
7	Horizontal & Vertical Cross Sections (1X Buck)				
8	Horizontal & Vertical Cross Sections (Direct to Masonry)				
9	Vertical Cross Sections (Thresholds)				
10	Horizontal & Vertical Cross Sections (Direct to Masonry)				
11	Buck anchoring				
12	Frame anchoring & hardware details				
13	Bill of materials and components				

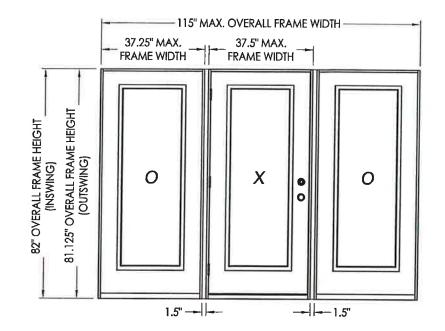


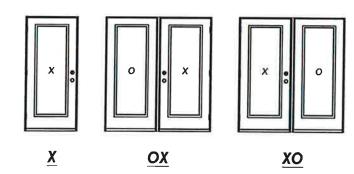


CONFIGURATION	MAX. FRAME	JAMB		ESSURE (PSF) WING	DESIGN PRESSURE (PSF) OUTSWING	
	DIMENSION	REINFORCEMENT	POSITIVE	NEGATIVE	POSITIVE	NEGATIVE
X	37.5" x 82.0"	N/A	+47.0	-47.0	+47.0	-47.0
	74.75" x 82.0"	N/A	+35.0	-40.0	+35.0	-35.0
OX/XO	75.5" x 82.0"	1X	+40.0	-45.0	+40.0	-40.0
	76.25" x 82.0"	2X	+50.0	-50.0	+50.0	-50.0
	112.0" x 82.0"	N/A	+35.0	-35.0	+35.0	-35.0
охо	113.5" x 82.0"	1X	+40.0	-45.0	+40.0	-40.0
	115.0" x 82.0"	2X	+47.0	-47.0	+47.0	-47.0

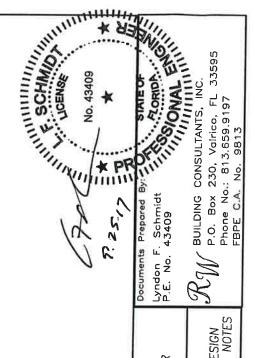



+++	-	⊢	+	1	ı
		UPDATE TO 5TH ED. (2014) FBC		REVISIONS	. עם.
	7/27/17	04/14/15	DATE		© 2014 R.W. BUILDING CONSULTANTS INC.
	2	-	NO.		OO
DATE: 10/	<sup>1</sup> 08,	/1	4		ט
SCALE:	N.T.	S.			ILD
DWG. BY:		JK	_		П
CHK, BY:	_	FS	_		. ≤
DRAWING N FL-1		17.	. 1		4 7
SHEET 1	OF	_1	3		0 20

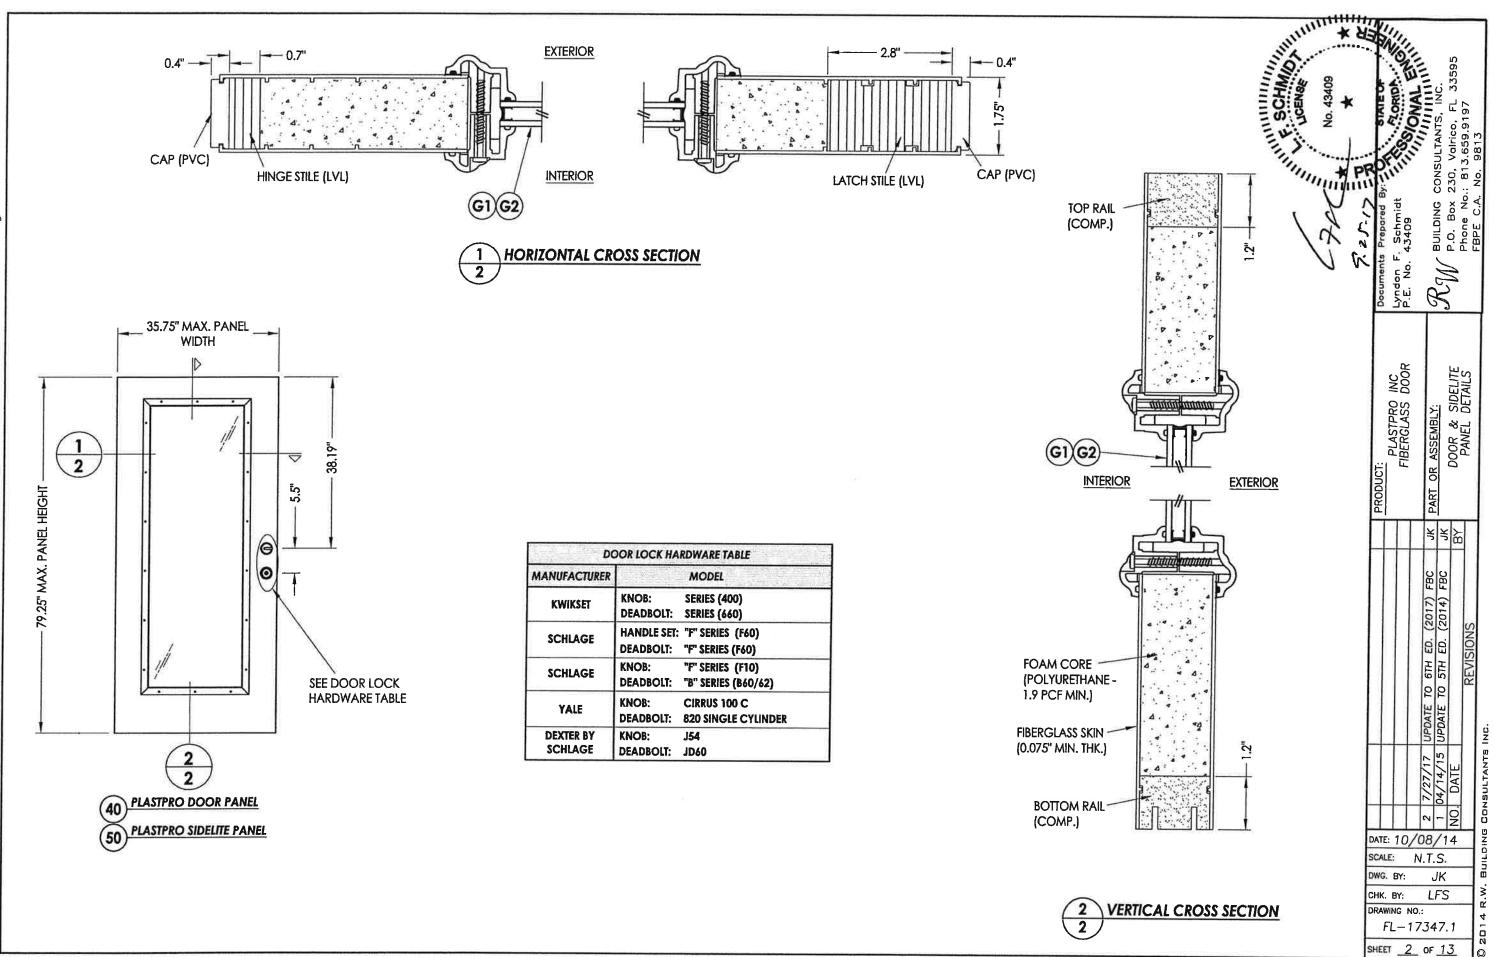


ings\FL-17347 6TH ED (2017)\FL-17347.1-2.dwg, 2.1

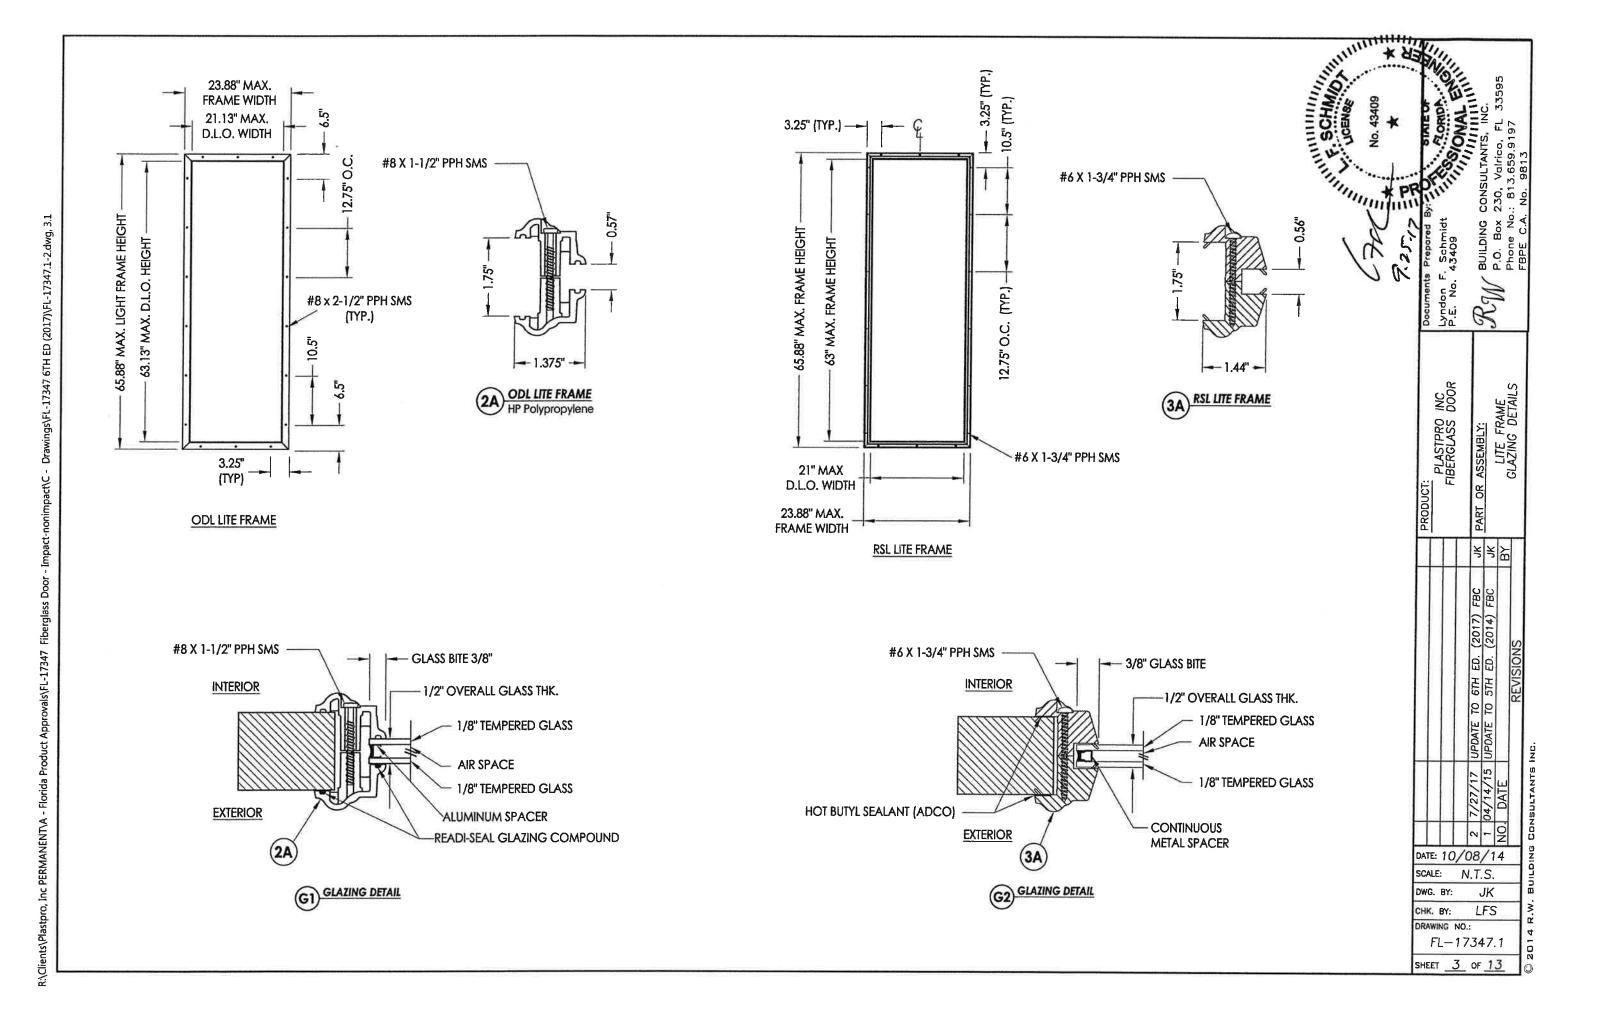


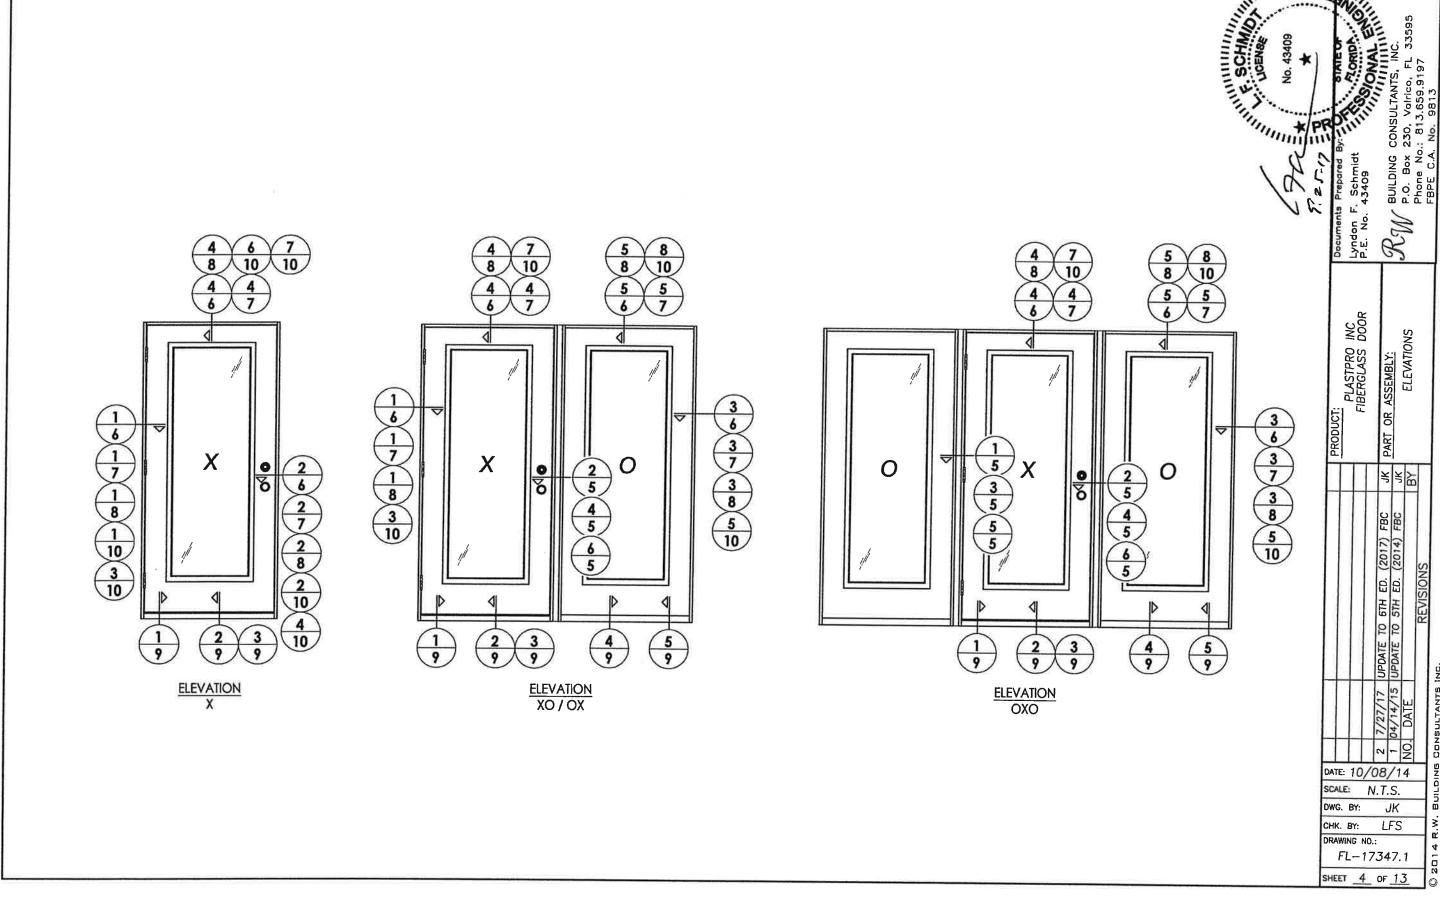

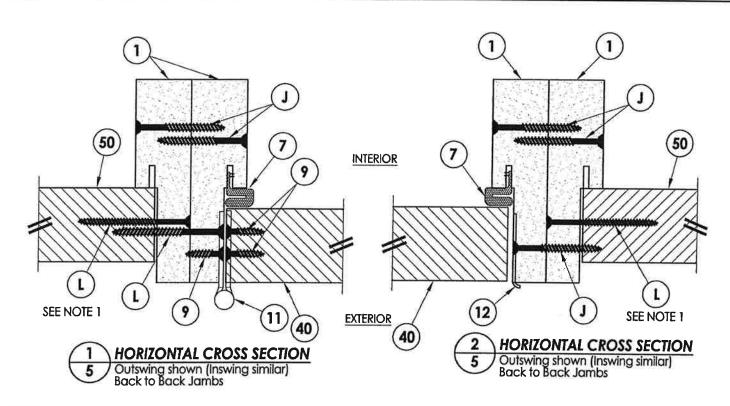

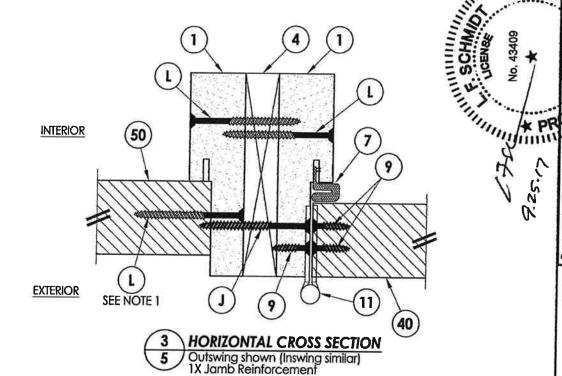

1. Spacing for item L: 6" from each end and 3 more equally spaced along sidelite jamb (5 total).

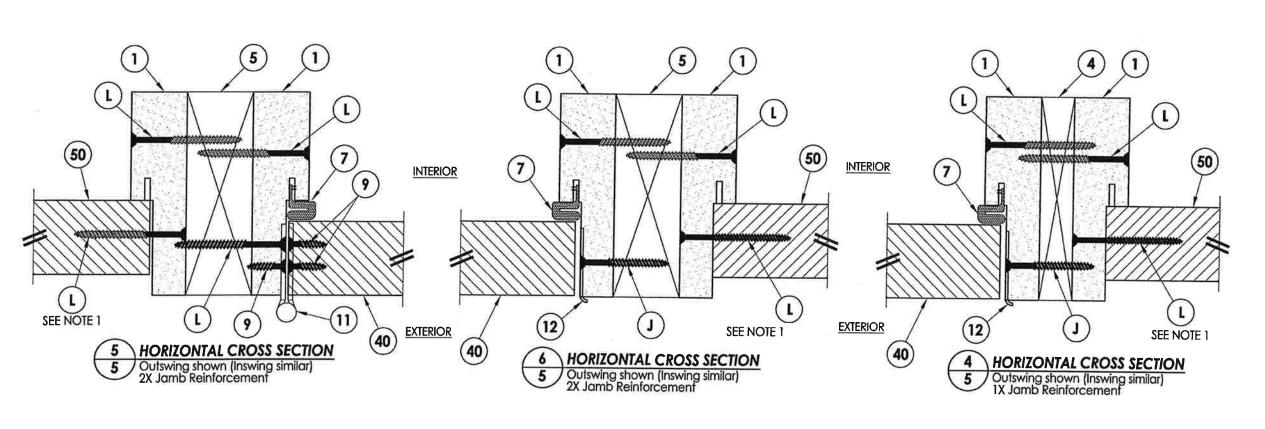


		_	_	<u>.</u>			J.
$\sqcup$			¥	¥	β		
			/17 UPDATE TO 6TH ED. (2017) FBC	_		REVISIONS	2016 R.W. BUILDING CONSULTANTS INC.
			[2]	04/14/15	DATE		NAT II ISI
			2	-	S.		ć
DATE:	10/				4		Z
SCALE	_	Ν	.Т.		_		חורב
DWG.	_	_	_	IK		_	>
CHK.		0.:		FS		$\dashv$	2
	1			7.	1		016
SHEET	_5		OF	1.	3		<u>2</u>

PLASTPRO INC FIBERGLASS DOOR

HORIZONTAL CROSS SECTIONS

npact\C - Drawings\FL-17347 6TH ED (2017)\FL-17347.1-2.dwg, 6.1

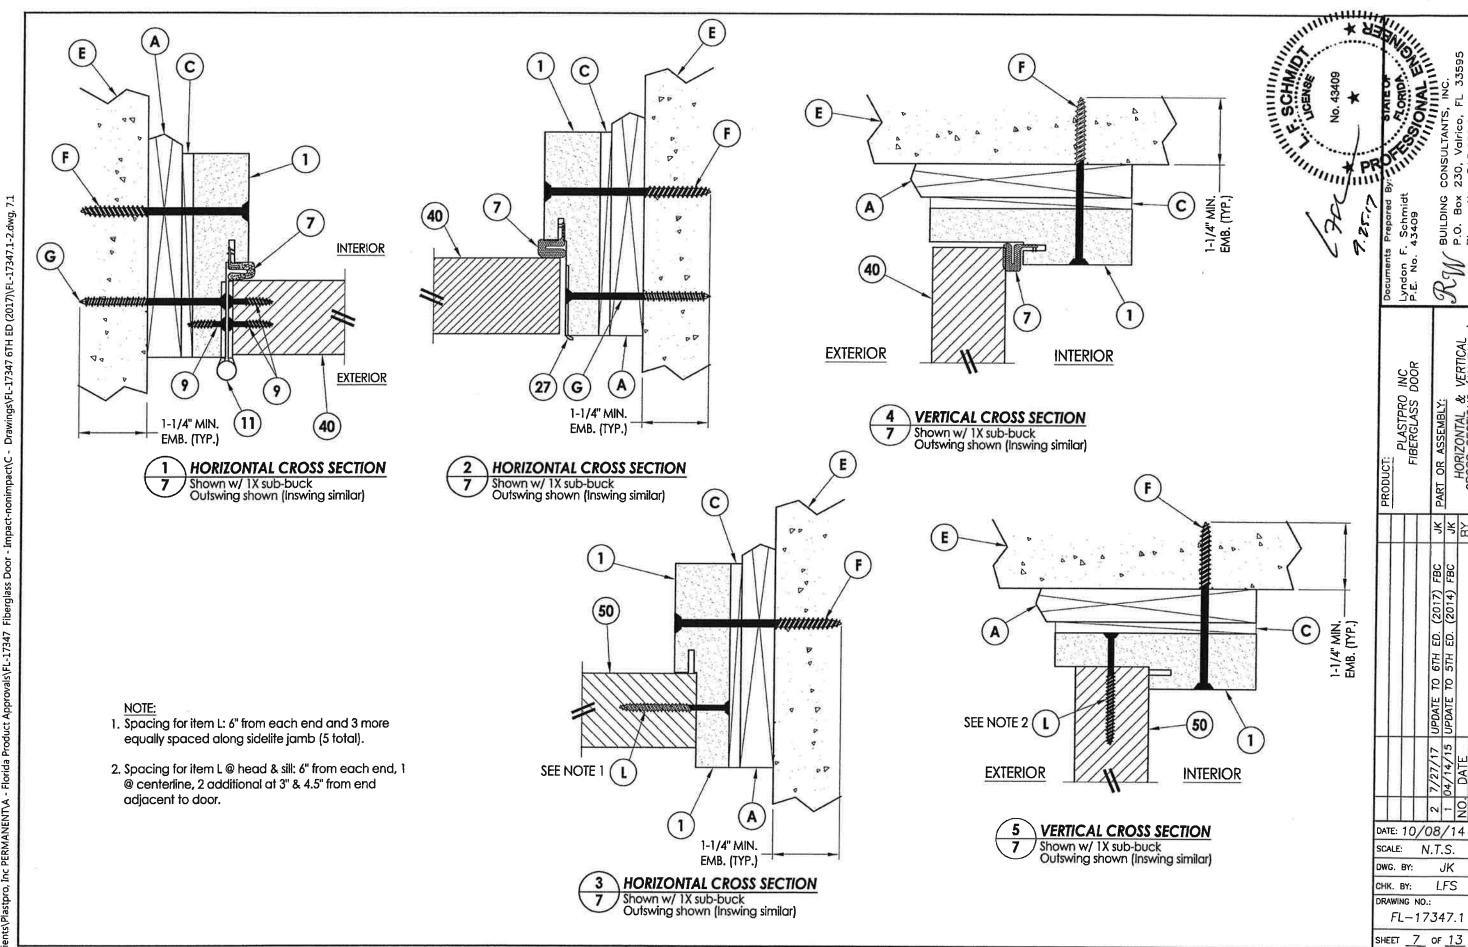

VERTICAL (1X BUCK)

HORIZONTAL & CROSS SECTIONS


6TH ED. (2017) FBC 5TH ED. (2014) FBC


UPDATE TO E


N.T.S.

JK

LFS

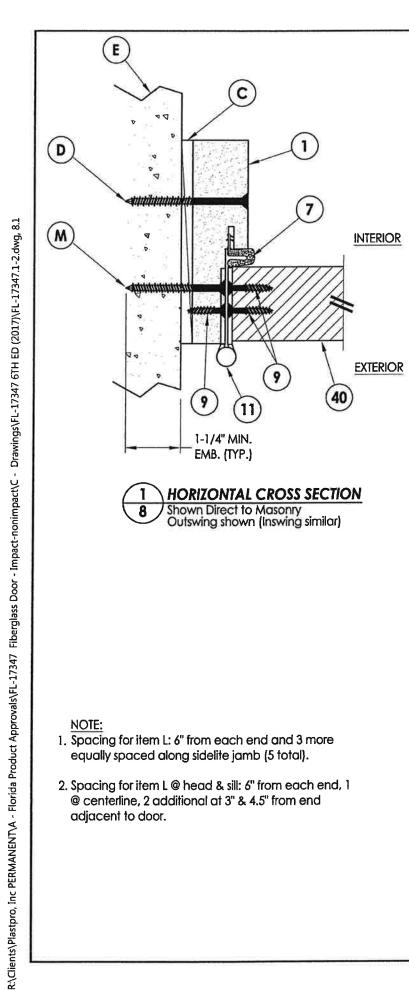

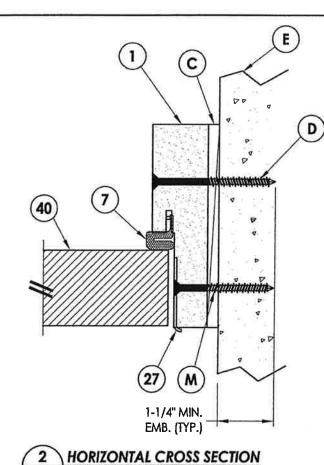

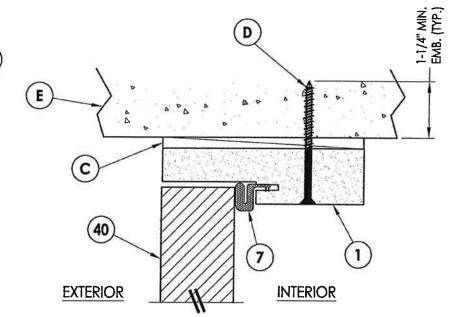


VERTICAL CROSS SECTION
Shown Direct to Masonry
Outswing shown (Inswing similar)

Shown Direct to Masonry Outswing shown (Inswing similar) (c)D (50) SEE NOTE 1 1-1/4" MIN. EMB. (TYP.)

> **HORIZONTAL CROSS SECTION** Shown Direct to Masonry Outswing shown (Inswing similar)


Shown Direct to Masonry Outswing shown (Inswing similar)

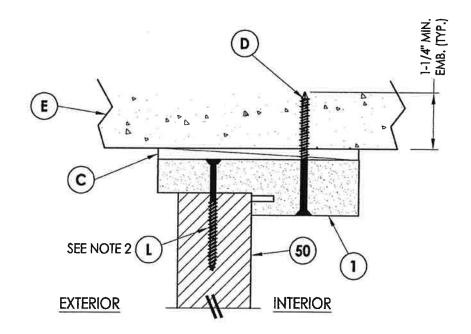


**VERTICAL CROSS SECTION** 

7.25. Lyndon F P.E. No. HORIZONTAL & VERTICAL CROSS SECTIONS (DIRECT TO MASONRY) PLASTPRO INC FIBERGLASS DOOR DATE: 10/08/14 SCALE: N.T.S. DWG. BY: JK LFS DRAWING NO .: FL-17347.1


SHEET \_8 OF 13

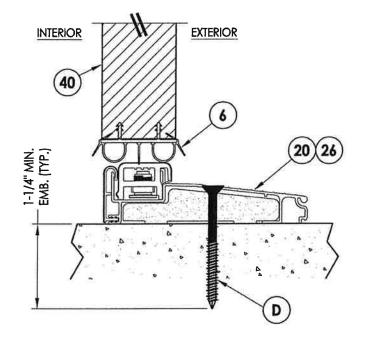


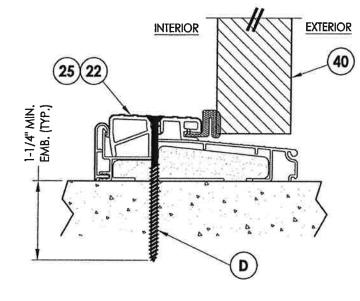

1 VERTICAL CROSS SECTION
9 Inswing sill


VERTICAL CROSS SECTION
 Outswing sill

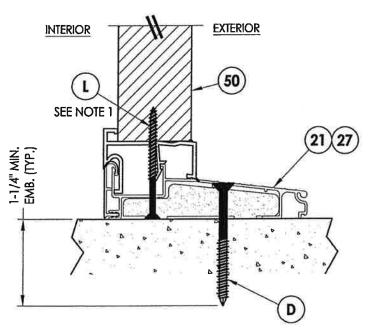

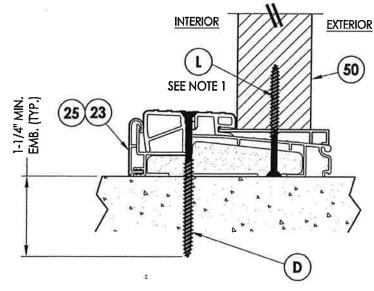

4 VERTICAL CROSS SECTION
9 Inswing sill

5 VERTICAL CROSS SECTION
9 Inswing sill

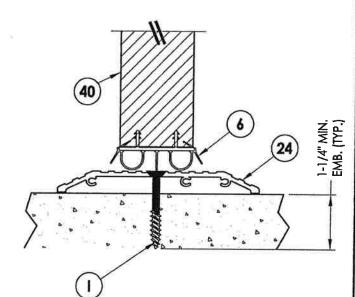

9 ADA SIII

NOTE:


1. Spacing for item L @ head & sill: 6" from each end, 1 @ centerline, 2 additional at 3" & 4.5" from end adjacent to door.

	2	$ \tilde{\mathbb{Z}} $		S	ı
	69	8		SION	
	HT9	STH		EVIS	
	5	2		œ	
	UPDATE	UPDATE TO STH ED.			, u
	7/27/17	04/14/15	DATE		016 R.W. BUILDING CONSULTANTS INC.
	2	-	NO		00
DATE: 10/	08	/1	4		Z
	V.T.	_			JI.
DWG. BY:	,	JK			ā
CHK. BY:	L	FS	;		3
DRAWING NO	.:				Ω.
FL-17	734	17.	. 1	- 1	-


SHEET 9 OF 13


VERTICAL CROSS SECTIONS (THRESHOLDS)

PLASTPRO INC FIBERGLASS DOOR

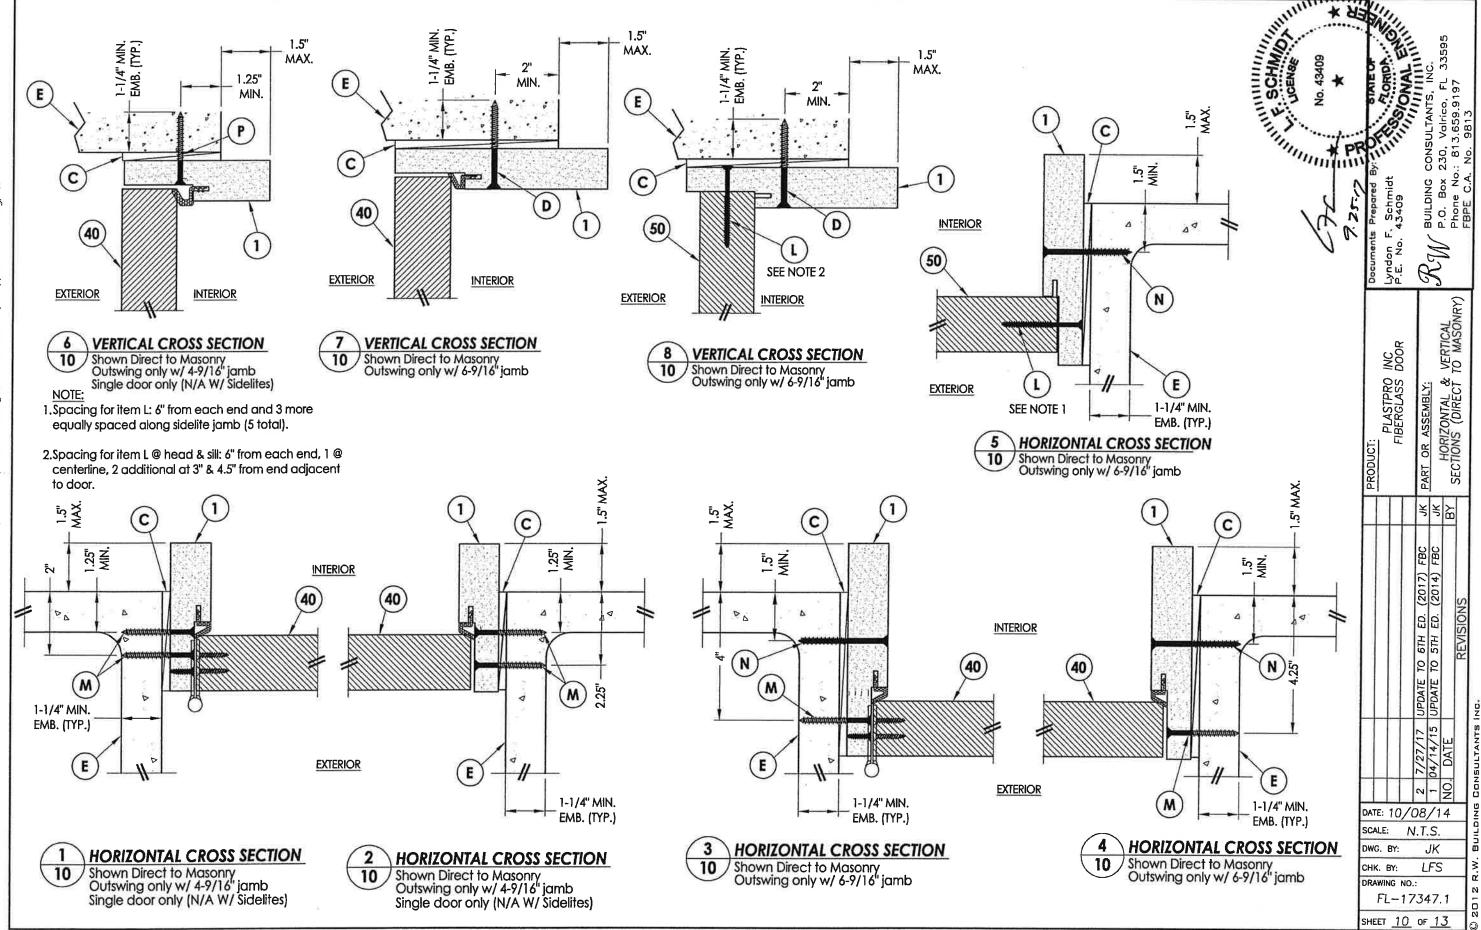

Fiberglass Door - Impact-nonimpact\C - Drawings\FL-17347 6TH ED (2017)\FL-17347.1-2.dwg, 10.1 R:\Clients\Plastpro, Inc PERMANENT\A - Florida Product Approvals\FL-17347

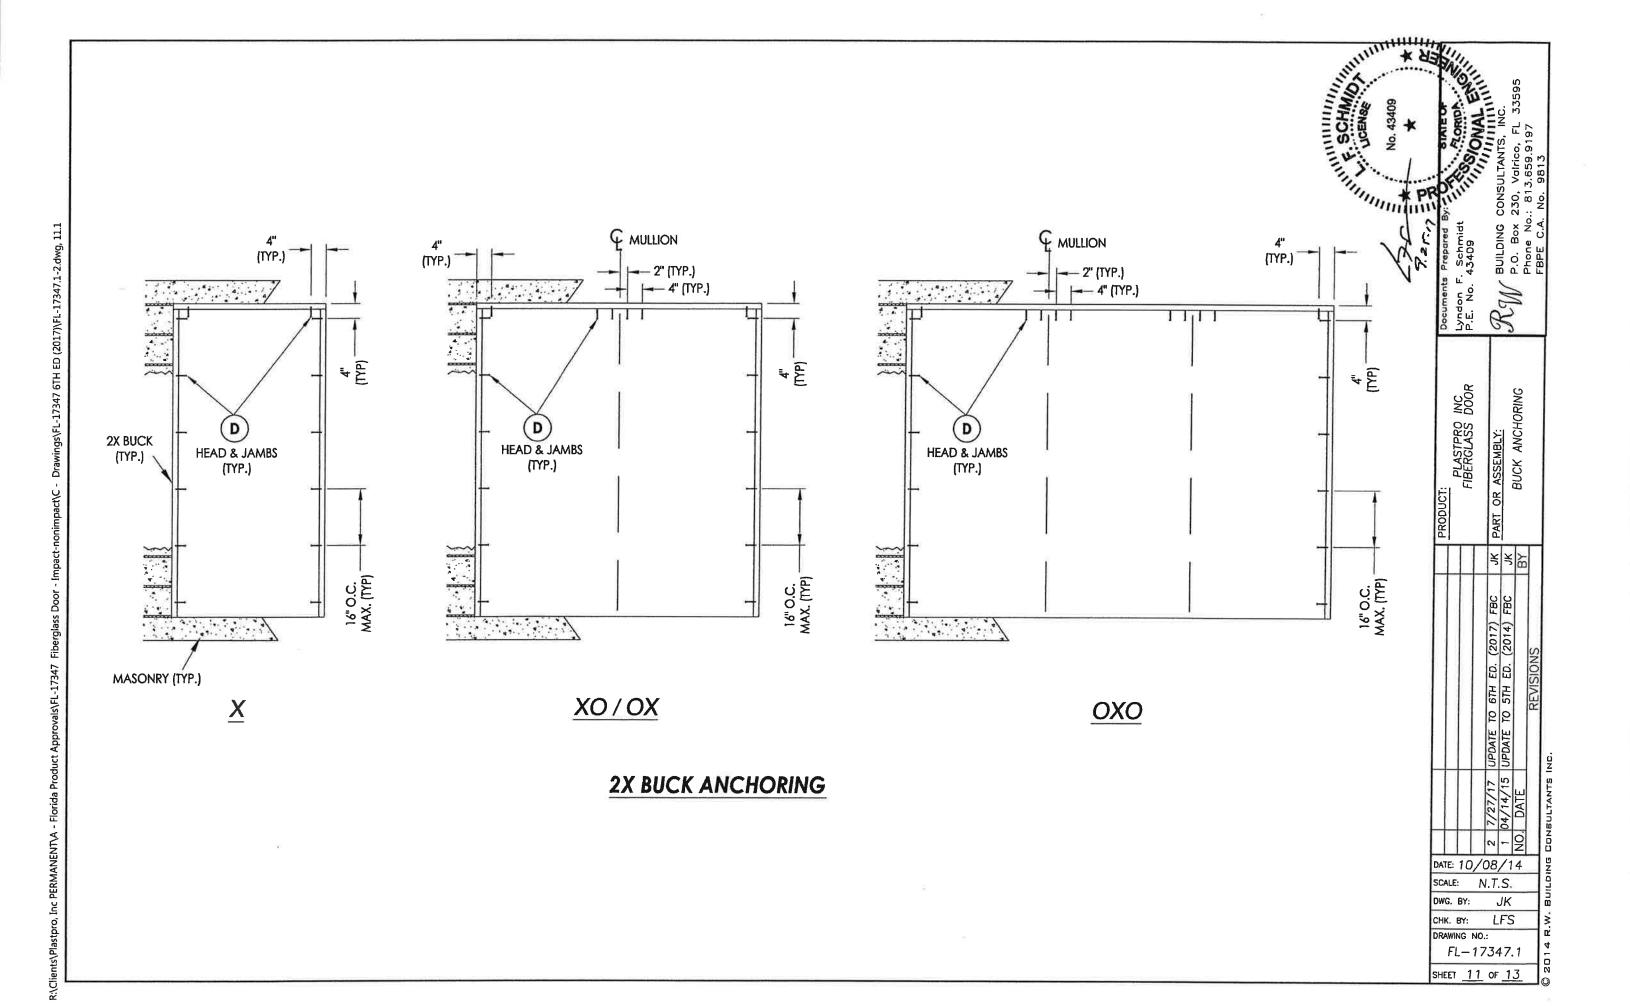

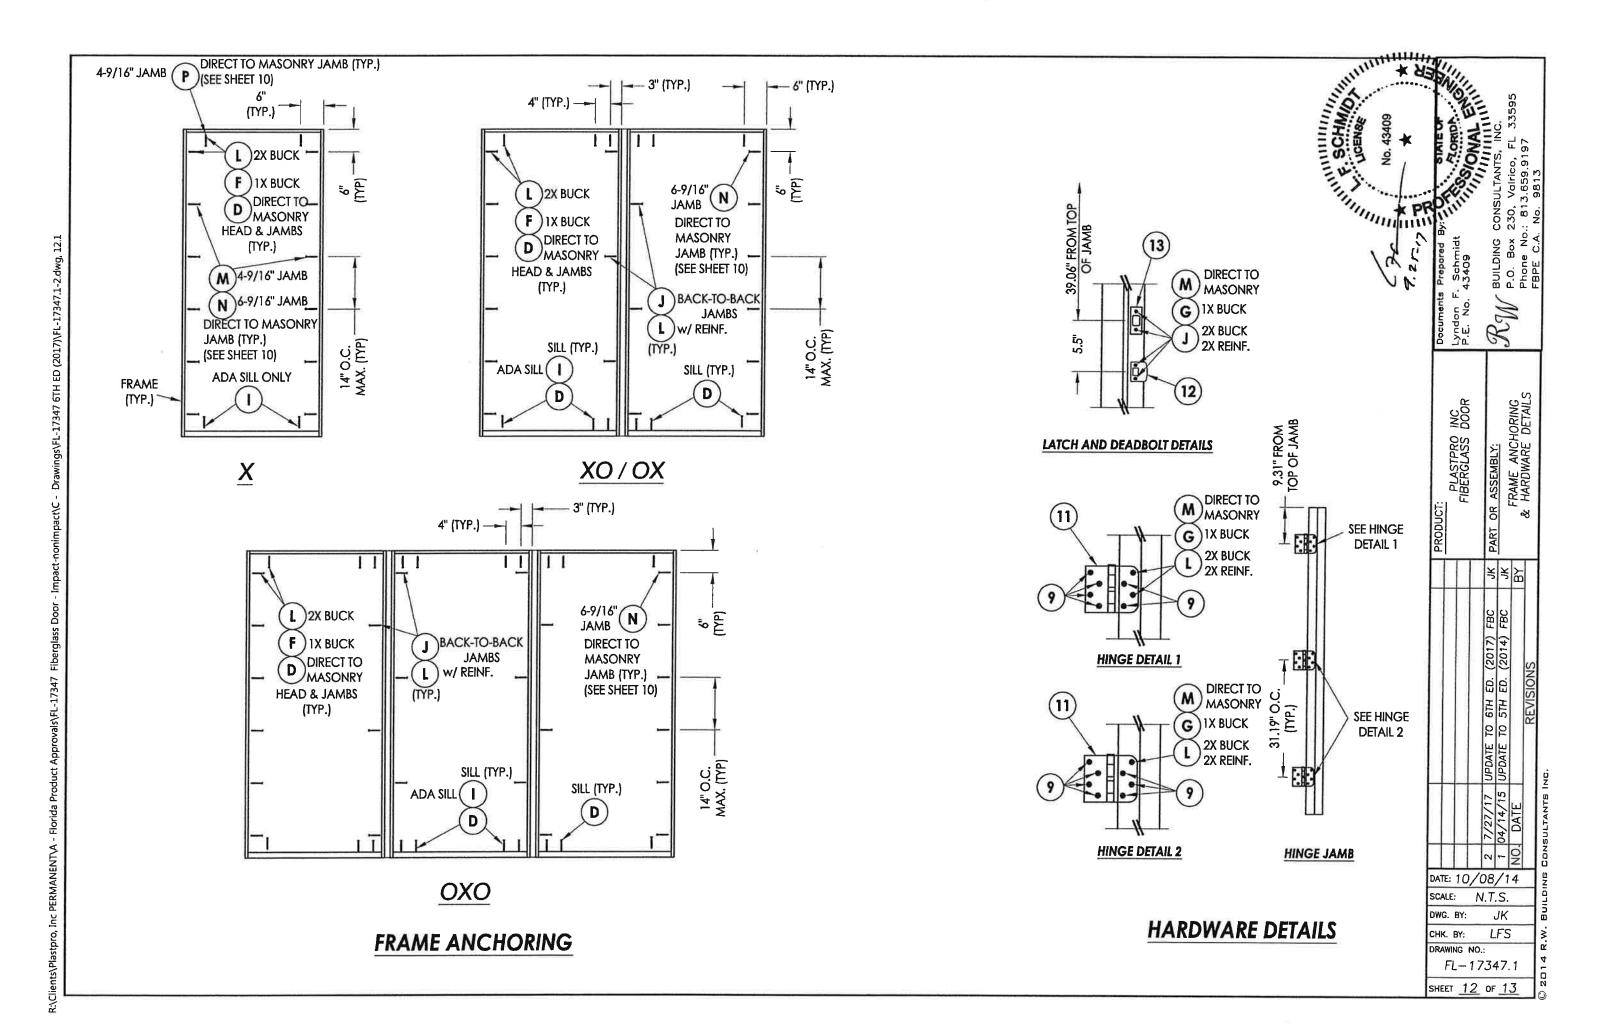

### CONCRETE ANCHOR NOTES:


- Concrete anchor locations at the corners may be adjusted to maintain the min. edge distance to mortar joints.
- Concrete anchor locations noted as "MAX. ON CENTER" must be adjusted to maintain the min. edge distance to mortar joints, additional concrete anchors may be required to ensure the "MAX. ON CENTER" dimension are not exceeded.
- 3. Concrete anchor table:


Drawings\FL-17347 6TH ED (2017)\FL-17347.1-2.dwg, 13.1

ANCHOR TYPE	ANCHOR SIZE	MIN. EMB <b>EDMENT</b>	MIN. CLEARANCE TO MASONRY EDGE	MIN. CLEARANCE TO ADJACENT ANCHOR
ITW BUILDEX	3/16"	1-1/4"	3"	1-1/2"
TAPCON®	1/4"	1-1/4"	2 <sup>n</sup>	4"
ELCO ULTRACON®	1/4"	1-1/4"	1"	<b>4</b> "


### WOOD SCREW INSTALLATION NOTES:

 Maintain a minimum 5/8" edge distance, 1" end distance, & 1" o.c. spacing of wood screws to prevent the splitting of wood.

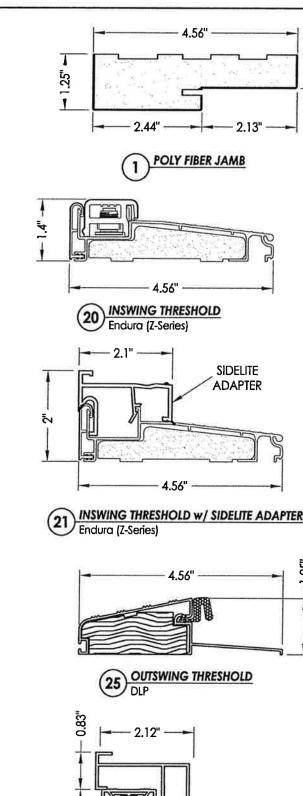


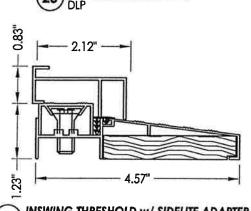


27 INSWING THRESHOLD W/ SIDELITE ADAPTER

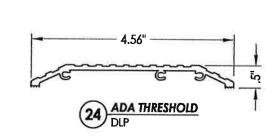


0.75"

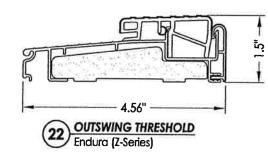

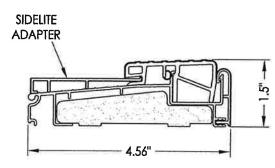

OUTSWING THRESHOLD w/ SIDELITE ADAPTER
Endura (Z-Series)

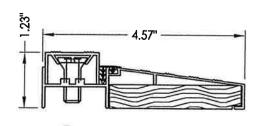

26 INSWING THRESHOLD DLP

Documents Prepa Lyndon F. Sch P.E. No. 4340	(				000	101
PRODUCT: PLASTPRO INC FIBERGLASS DOOR		JK PART OR ASSEMBLY:			& COMPONENIS	
	1	ž	충	BY		
	2 7/27/17 HEDATE TO ETH ED 7/27/17	- 1	1 04/14/13 UPDATE 10 STH ED. (2014) FBC		REVISIONS	מטי
	71/2017 6	01/11/11	01/41/40	NO. DATE		CONSULTANTS INC.
ATE: 10,	/08	_	1	4		Ü
CALE:	N.					R.W. BUILDI
WG. BY:		_	K			<u>.</u>
HK. BY:		LF	S	_	4	3
FL-1		4	7.	1	1	4
		_		_	$\dashv$	201
HEET 1.		<u>-</u>		<u>-</u>	┙	0





BCIS Home | Log In | User Registration | Hot Topics | Submit Surcharge | Stats & Facts | Publications

Contact Us | BCIS Site Map | Links





Product Approval Menu > Product or Application Search > Application List > Application Detail

Application Type Code Version Application Status FL17347-R2 Revision 2017 Approved

Comments Archived

Product Manufacturer Address/Phone/Email

Plastpro Inc. / Nanya Plastics Corp.

5200 W CENTURY BLVD. LOS ANGELES, CA 90045 (440) 969-9773 Ext 16 rickw@rwbldgconsultants.com

Authorized Signature

Vivian Wright

rickw@rwbldgconsultants.com

Technical Representative

Address/Phone/Email

Scott Johnson

5200 W Century Blvd. Los Angeles, CA 90045 (440) 969-9773 Ext 18 scottjohnson@plastproinc.com

Quality Assurance Representative Address/Phone/Email

Category Subcategory Exterior Doors

Swinging Exterior Door Assemblies

Compliance Method

Evaluation Report from a Florida Registered Architect or a Licensed

Florida Professional Engineer

Lyndon F. Schmidt, P.E.

Evaluation Report - Hardcopy Received

Florida Engineer or Architect Name who developed

the Evaluation Report

Florida License Quality Assurance Entity PE-43409

National Accreditation and Management Institute 12/31/2019

Quality Assurance Contract Expiration Date Validated By

Ryan J. King, P.E.

☑ Validation Checklist - Hardcopy Received

Certificate of Independence

FL17347 R2 COI (a) Certificate of Independence.pdf

Referenced Standard and Year (of Standard)

**Standard Year** 101/I.S.2/NAFS 2002 AAMA/WDMA/CSA101/I.S.2/A440 2008 **ASTM E1886** 2002 **ASTM E1996** 2002 ASTM E330 2002 ASTM E331 2000 TAS 201, 202, 203 1994

Equivalence of Product Standards

Certified By

Florida Licensed Professional Engineer or Architect FL17347 R2 Equiv (b) Equivalency Of Standards.pdf Sections from the Code

Product Approval Method Method 1 Option D Date Submitted 08/13/2017 Date Validated 09/26/2017 Date Pending FBC Approval 09/29/2017 Date Approved 12/12/2017

FL#	Model, Number or Name	Description
17347.1	a. Fiberglass Door	"Non-Impact" Fiberglass Glazed Door - Single with or without Sidelites (X, OX or XO, OXO) Outswing/Inswing Configurations up to Nominal 6'8 in Height
Impact Resista Design Pressur Other: See INST	se outside HVHZ: Yes nt: No	Installation Instructions FL17347 R2 II (b) Inst 17347.1.pdf Verifled By: Lyndon F. Schmidt, P.E. 43409 Created by Independent Third Party: Yes Evaluation Reports FL17347 R2 AE (b) Eval 17347.1.pdf Created by Independent Third Party: Yes
17347.2	b. Fiberglass Door	"Non-Impact" Fiberglass Glazed Door - Double with or without Sidelites (XX or OXXO) Outswing/Inswing Configurations up to Nominal 6'8 in Height
Limits of Use Approved for use in HVHZ: No Approved for use outside HVHZ: Yes Impact Resistant: No Design Pressure: N/A Other: See INST 17347.2 for any additional use limitations, installation instructions and product particulars.		Installation Instructions FL17347 R2 II (b) Inst 17347.2.pdf Verified By: Lyndon F. Schmidt, P.E. 43409 Created by Independent Third Party: Yes Evaluation Reports FL17347 R2 AE (b) Eval 17347.2.pdf Created by Independent Third Party: Yes
17347.3	c. Fiberglass Door	"Non-Impact" Fiberglass Glazed Door - Single with or without Sidelites (X, OX or XO, OXO) Outswing/Inswing Configurations up to Nominal 8'0 in Height
Limits of Use Approved for use in HVHZ: No Approved for use outside HVHZ: Yes Impact Resistant: No Design Pressure: N/A Other: See INST 17347.3 for any additional use limitations, installation instructions and product particulars.		Installation Instructions FL17347 R2 II (b) Inst 17347.3.pdf Verified By: Lyndon F. Schmidt, P.E. 43409 Created by Independent Third Party: Yes Evaluation Reports FL17347 R2 AE (b) Eval 17347.3.pdf Created by Independent Third Party: Yes
17347.4	d. Fiberglass Door	"Non-Impact" Fiberglass Glazed Door - Double with or without Sidelites (XX or OXXO) Outswing/Inswing Configurations up to Nominal 8'0 in Height
Limits of Use Approved for use in HVHZ: No Approved for use outside HVHZ: Yes Impact Resistant: No Design Pressure: N/A Other: See INST 17347.4 for any additional use limitations, installation instructions and product particulars.		Installation Instructions FL17347 R2 II (b) Inst 17347.4.pdf Verified By: Lyndon F. Schmidt, P.E. 43409 Created by Independent Third Party: Yes Evaluation Reports FL17347 R2 AE (b) Eval 17347.4.pdf Created by Independent Third Party: Yes
17347.5	e. Fiberglass Door	"Impact" Fiberglass Glazed Door - Single with or without Sidelites (X, OX or XO, OXO) Outswing/Inswing Configurations up to Nominal 6'8 in Height
Impact Resistar Design Pressure Other: See INST	se outside HVHZ: Yes nt: Yes	Installation Instructions FL17347 R2 II (b) Inst 17347.5.pdf Verified By: Lyndon F. Schmidt, P.E. 43409 Created by Independent Third Party: Yes Evaluation Reports FL17347 R2 AE (b) Eval 17347.5.pdf Created by Independent Third Party: Yes
17347.6	f. Fiberglass Door	"Impact" Fiberglass Glazed Door - Double with or without Sidelites (XX or OXXO) Outswing/Inswing Configurations up to Nominal 6'8 in Height
Limits of Use Approved for us	se in HVHZ: No	Installation Instructions FL17347 R2 II (b) Inst 17347.6.pdf



# plastpro

5200 W. CENTURY BLVD. LOS ANGELES, CA 90045


# GLAZED FIBERGLASS DOORS DOUBLES w/ or w/o SIDELITES

INSWING / OUTSWING "NON-IMPACT"

### **GENERAL NOTES**

- 1. This product has been evaluated and is in compliance with the 6th Edition (2017) Florida Building Code (FBC) structural requirements excluding the "High Velocity Hurricane Zone" (HVHZ).
- 2. Product anchors shall be as listed and spaced as shown on details. Anchor embedment to base material shall be beyond wall dressing or stucco.
- 3. When used in areas requiring wind borne debris protection, this product is required to be protected with an impact resistant covering that complies with FBC Sections 1609.1.2 & R301.2.1.2.
- 4. For 2x stud framing construction, anchoring of these units shall be the same as that shown for 2x buck masonry construction.
- 5. Site conditions that deviate from the details of this drawing require further engineering analysis by a licensed engineer or registered architect.


	TABLE OF CONTENTS			
SHEET#	DESCRIPTION			
1	Typical elevations, design pressures & general notes			
2	Door & Sidelite panel details			
3	Lite frame glazing details			
4	Elevations			
5	Horizontal & Vertical Cross Sections (2X Buck)			
6	Horizontal & Vertical Cross Sections (1X Buck)			
7	Horizontal & Vertical Cross Sections (Direct to Masonry)			
8	Vertical Cross Sections (Thresholds)			
9	Horizontal & Vertical Cross Sections (Direct to Masonry)			
10	Buck anchoring			
11	Frame anchoring & hardware details			
12	Bill of materials and components			

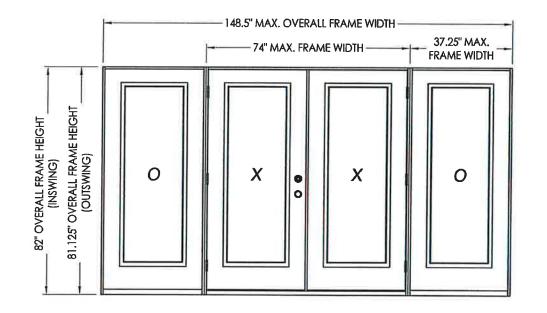






CONFIG.	MAX. FRAME DIMENSION	DESIGN PRESSURE (PSF) INSWING		DESIGN PRESSURE (PSF) OUTSWING	
	DIMENSION	POS.	NEG.	POS.	NEG.
XX	74.0" x 82.0"	1470	47.0	. 47.0	47.0
оххо	148.5" x 82.0"	+47.0	-47.0	+47.0	-47.0


アントラー	Documents Prepared By:	Apimoo u	P.E. No. 43409			SOUTH PRINCE CONS	// P.O. Box 230,	1000 BUOLL 0	TELE C.A. NO.
	Docur	7000	, m		6		-	<u>~</u>	
	PRODUCT:	PLASTPRO INC	1 FIBERGLASS DOOR		JK PART OR ASSEMBLY.		TYPICAL ELEVATION, DESIGN	PRESSURES & GENERAL NOIE	
					ž	¥	益		
					/17   UPDATE TO 6TH ED. (2017) FBC	4/15 UPDATE TO 5TH ED. (2014) FBC		REVISIONS	ישויים.
	DAT	E:	10		0 2 7/27/17	1 04/14	A NO. DATE		2014 R.W. BUILDING CONSULTANTS INC.
- 1-	SCA	_		_	Т.	S,	0		וורסוו
- 1	OWC	-	3Y:		_	JK	_	_	/. BL
- 1	ORA	WIN				FS 17.			J14 R.W
5	SHE	ET	_	L	OF	1	2		22(

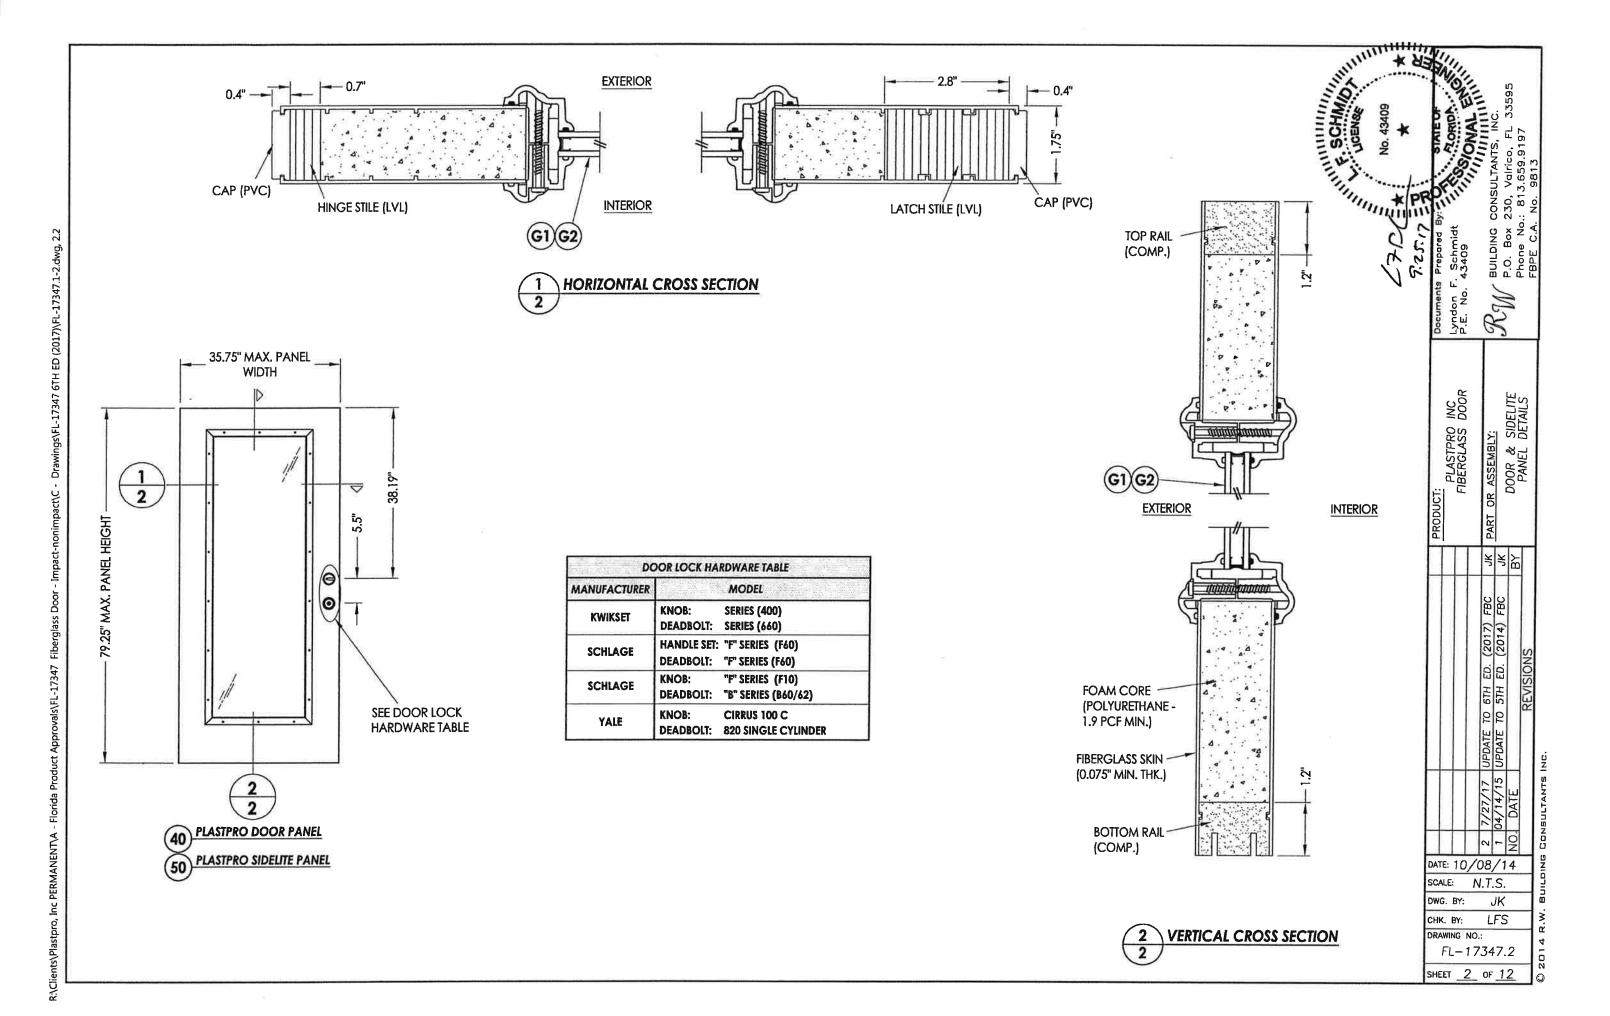

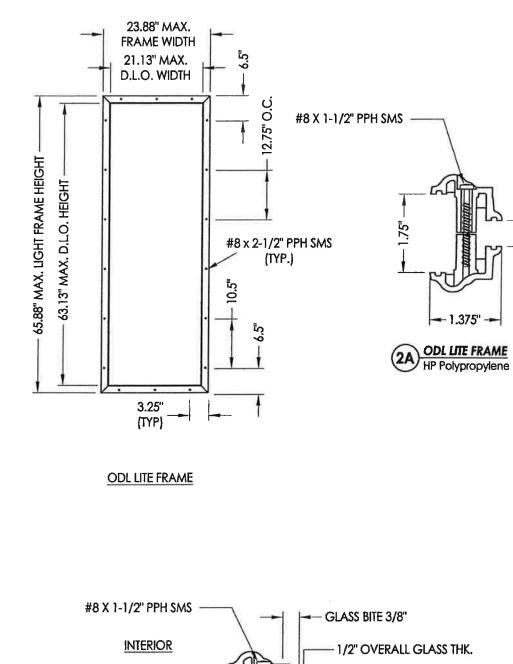

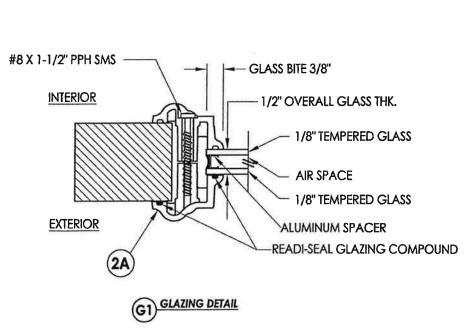

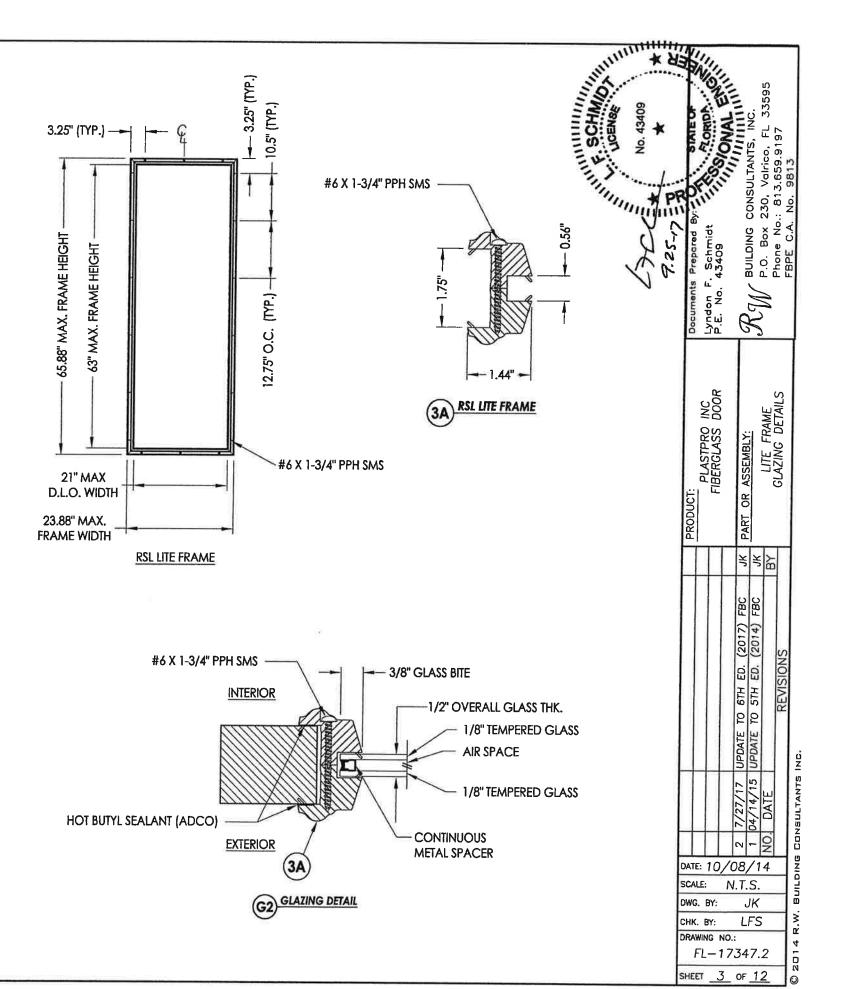

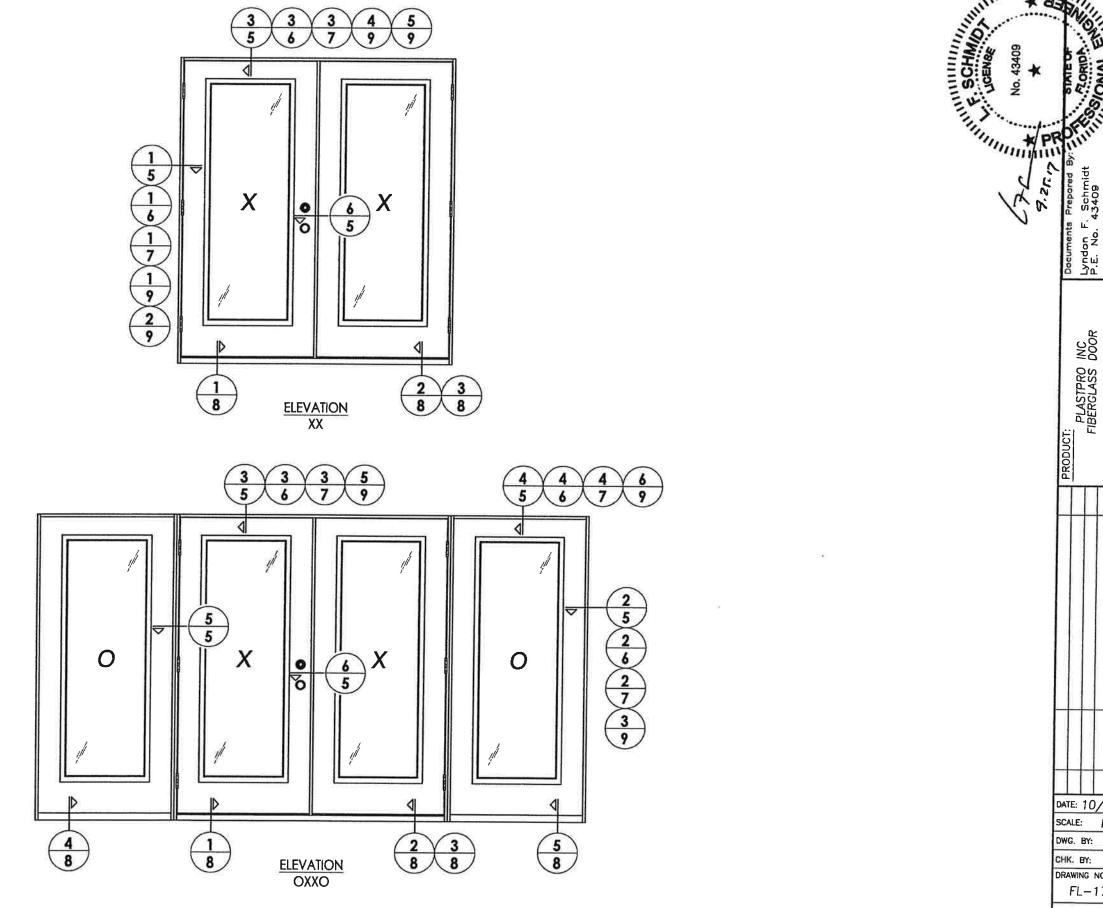

ovals\FL-17347 Fiberglass Door - Impact-nonimpact\C - Drawings\FL-17347 6TH ED (2017)\FL-17347.1-2.dwg, 4.2 R:\Clients\Plastpro, Inc PERMANENT\A - Florida Product App

DATE: 10/08/14 SCALE: N.T.S. JK LFS

UPDATE TO 6TH ED. (2017) FBC UPDATE TO 5TH ED. (2014) FBC


ASSEMBLY: ELEVATIONS

DRAWING NO .: FL-17347.2


SHEET 4 OF 12

mpact\C - Drawings\FL-17347 6TH ED (2017\\FL-17347.1-2.dwg, 5.2 R:\Clients\Plastpro, Inc PERMANENT\A - Florida Product Appr



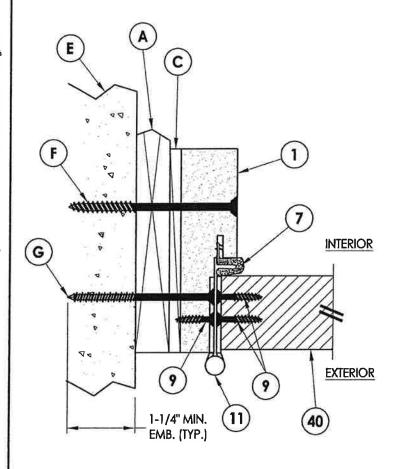

HORIZONTAL CROSS SECTION Shown w/ 1X sub-buck Outswing shown (Inswing similar)

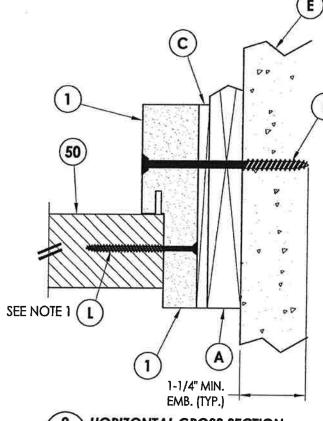


(A)

HORIZONTAL CROSS SECTION Shown w/ 1X sub-buck Outswing shown (Inswing similar)

HOS WALLEN TO STATE OF THE PARTY OF THE PART C (A) (40) **EXTERIOR** INTERIOR

> **VERTICAL CROSS SECTION** Shown w/ 1X sub-buck Outswing shown (Inswing similar)

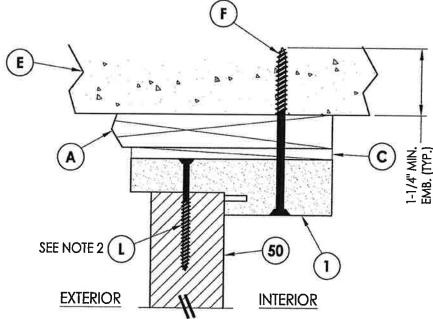

VERTICAL CROSS SECTION Shown w/ 1X sub-buck Outswing shown (Inswing similar)

1. Spacing for item L: 6" from each end and 3 more equally spaced along sidelite jamb (5 total).

2. Spacing for item L @ head & sill: 6" from each end, 1 @ centerline, 2 additional at 3" & 4.5" from end adjacent to door.

JPDATE TO 6TH ED. (2017) FBC JPDATE TO 5TH ED. (2014) FBC DATE: 10/08/14 N.T.S. DWG. BY: JK LFS CHK. BY: DRAWING NO .:

SCALE:

FL-17347.2 SHEET 6 OF 12


Lyndon F. Schrr P.E. No. 43409

INC DOOR


PLASTPRO FIBERGLASS [

VERTICAL (1X BUCK)




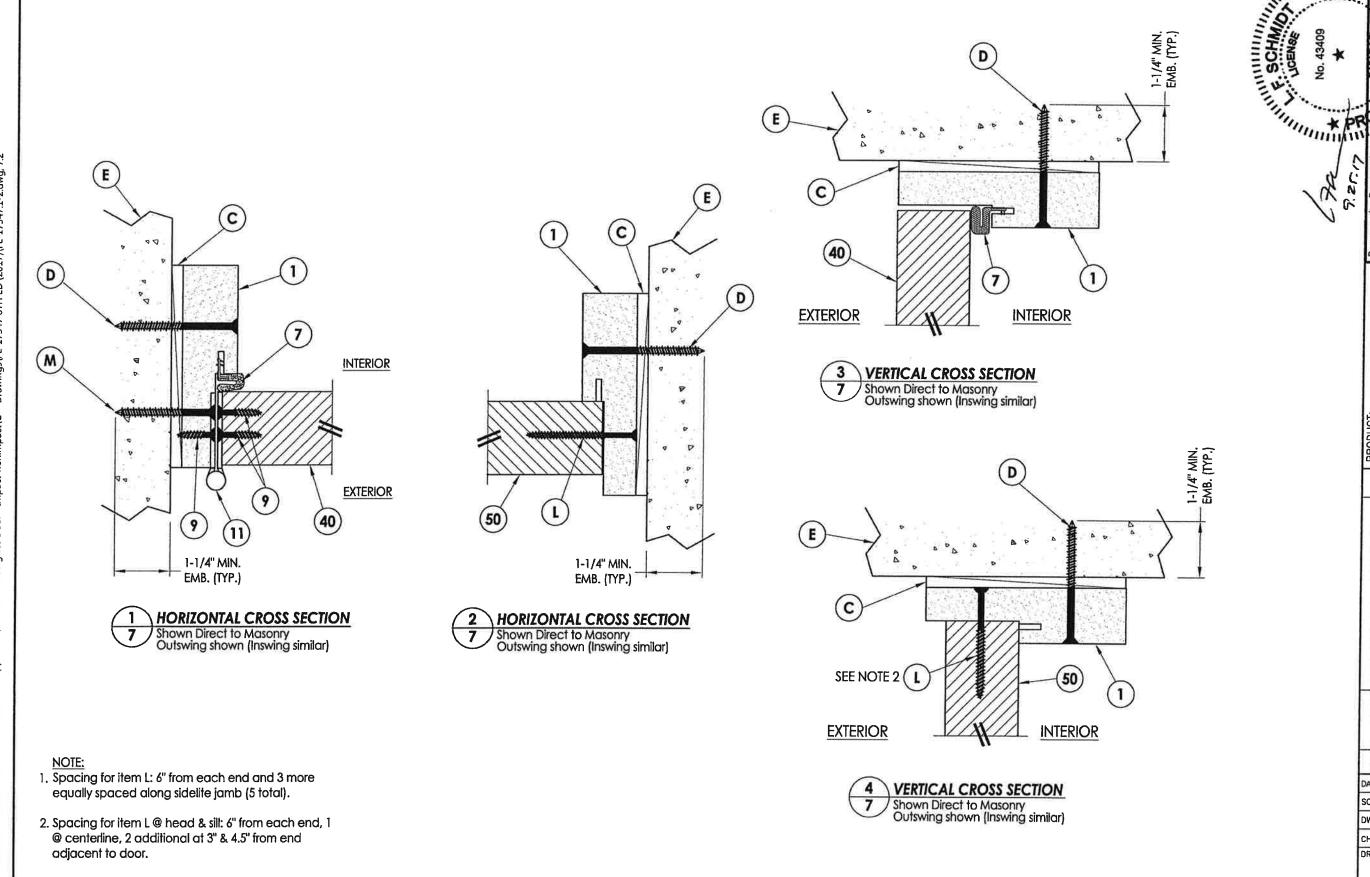


HORIZONTAL & VERTICAL CROSS SECTIONS (DIRECT TO MASONRY) PLASTPRO INC FIBERGLASS DOOR (2017) 8 8 6TH 5TH 55 DATE: 10/08/14 SCALE: N.T.S. DWG. BY: JK LFS CHK. BY: DRAWING NO .: FL-17347.2 SHEET \_ 7 OF 12

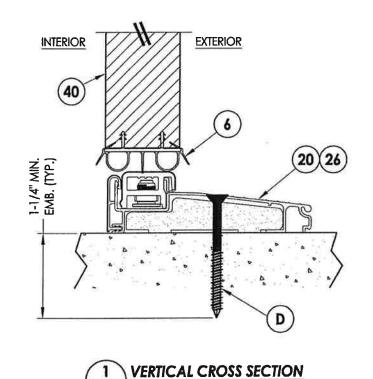

/ Inswing sill

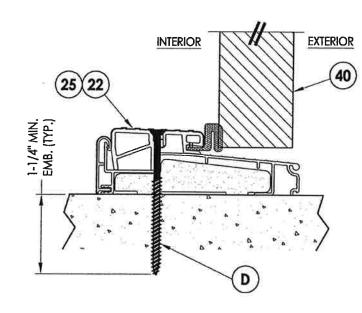


VERTICAL CROSS SECTION Outswing sill

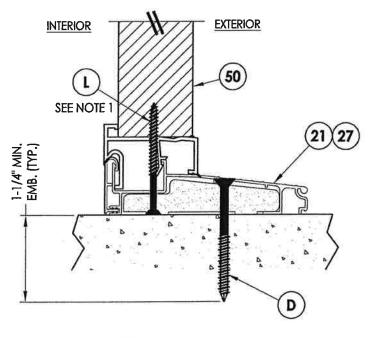


Inswing sill

**VERTICAL CROSS SECTION** 

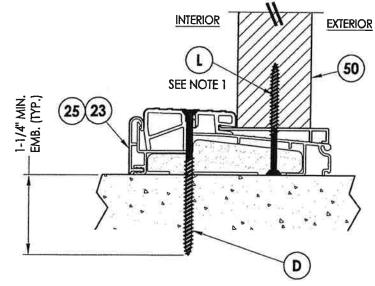

VERTICAL CROSS SECTION Inswing sill

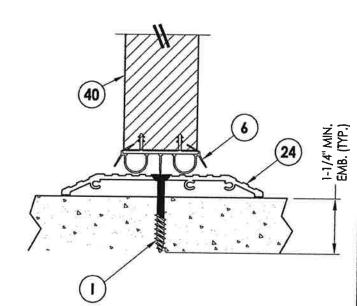

VERTICAL CROSS SECTION
ADA SIII


NOTE:
1. Spacing for item L @ head & sill: 6" from each end,
2 additional at 3" & 4.5" from end adjacent to door.

					וייס		3	
				2	2		-	
				UPDATE TO	UPDATE TO			9
				7/27/17	04/14/15	DATE		6 R.W. BUILDING CONSTITANTS INC
				2	1	NO.		6
DA	TE:	10	/	28	/1	4		2
sc	ALE	:	Λ	I.T	S.			5
DWG. BY: JK								Ē
CHK. BY: LFS								3
DR	AWI	VG I	١٥.	:			7	8


PLASTPRO INC FIBERGLASS DOOR

FL-17347.2 SHEET 8 OF 12




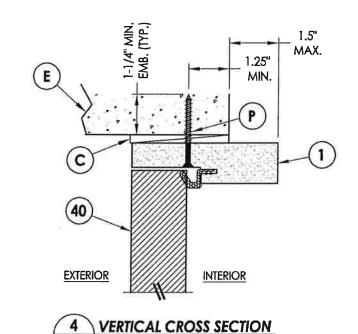

Shown Direct to Masonry Outswing only w/ 4-9/16" jamb Double Door Only (N/A w/ Sidelites)

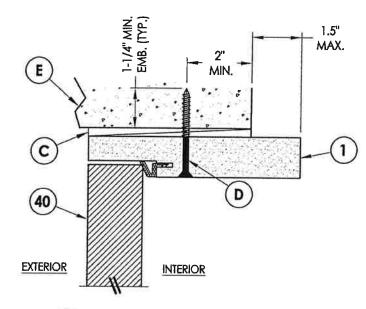




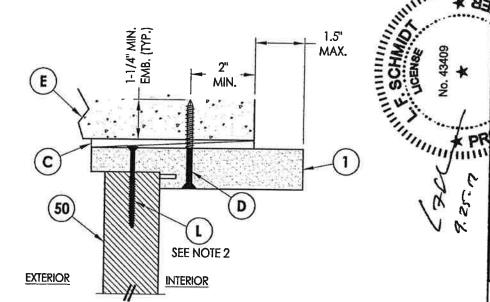


**VERTICAL CROSS SECTION** Shown Direct to Masonry Outswing only w/ 6-9/16" jamb


- 1. Sidelite assembly screws located 6" from top and bottom then 5 more equally spaced (7 total).
- 2. Spacing for item L: 3" from each end and @ center line (3 total).

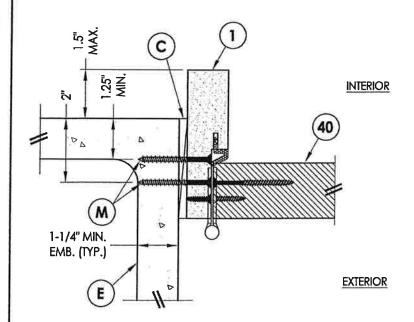



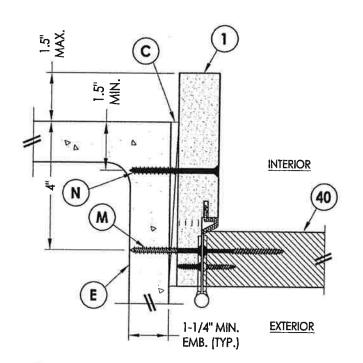

HORIZONTAL CROSS SECTION Shown Direct to Masonry Outswing only w/ 6-9/16" jamb

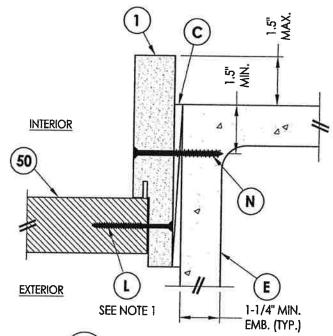

Shown Direct to Masonry Outswing only w/ 6-9/16" jamb

	1	©	- 1.5" MAX.
INTERIOR		7 - S. I. S.	04
50			<b>v</b> )
EXTERIOR	L - SEE NOTE 1		E -1/4" MIN.
(3	HORIZONI	AL CROSS S	MB. (TYP.) SECTION

DATE: 10/08/14 SCALE: N.T.S. DWG. BY: JK LFS CHK. BY: DRAWING NO .: FL-17347.2

SHEET 9 OF 12


Lyndon F P.E. No.

INC DOOR

PLASTPRO FIBERGLASS

 $\mathcal{R}_{\mathcal{M}}$ 

HORIZONTAL & SECTIONS (DIRECT

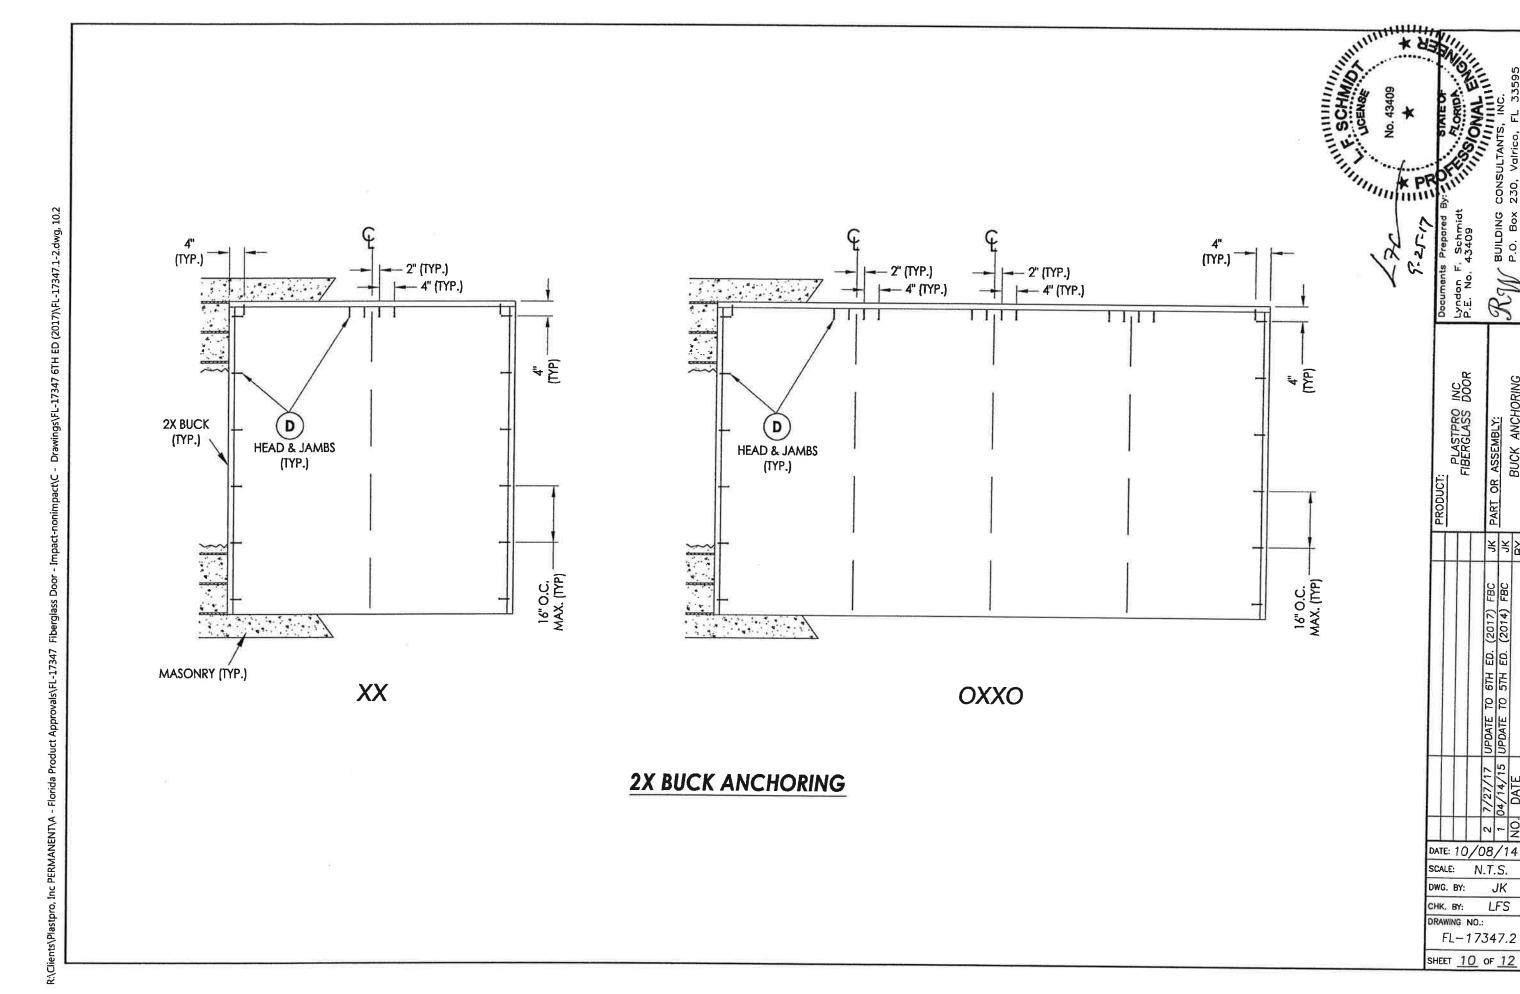


N.T.S.

LFS

PLASTPRO INC FIBERGLASS DOOR

OR ASSEMBLY: BUCK ANCHORING

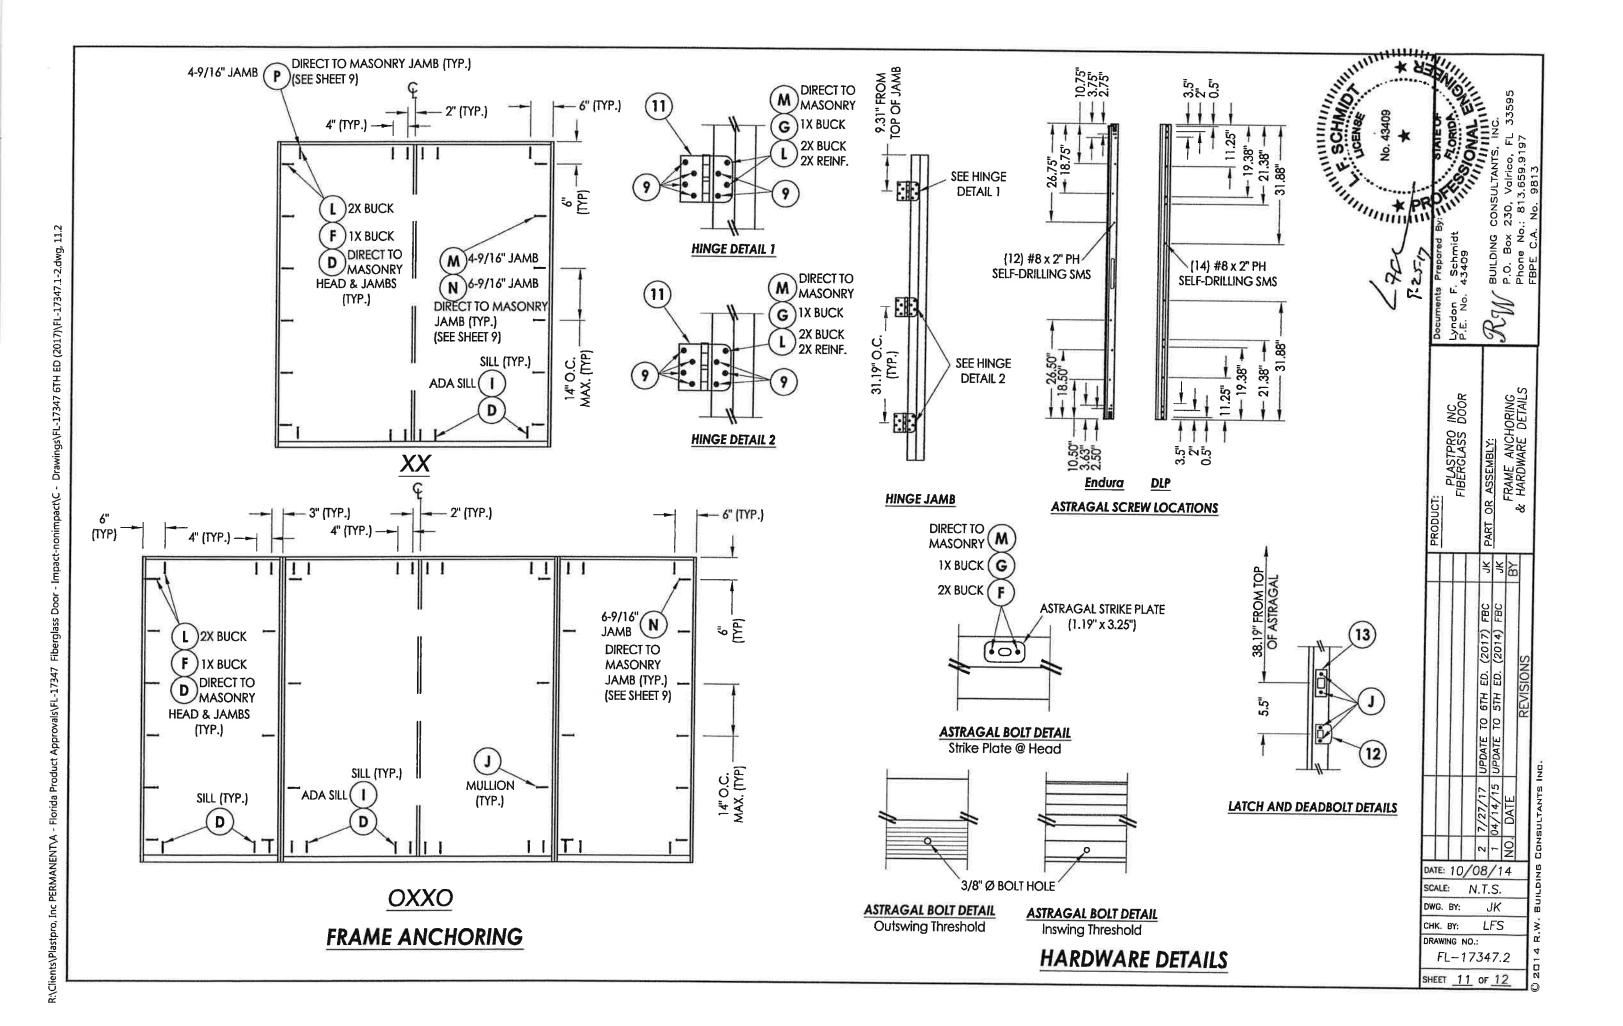

	BILL OF MATERIALS	
ПЕМ #	DESCRIPTION	MATERIAL
Α	1X BUCK (G >= 0.42)	WOOD
В	2X BUCK (G >= 0.42)	WOOD
С	1/4" MAX. SHIM SPACE	
D	1/4" PFH CONCRETE SCREW (1-1/4" MIN. EMB.)	STEEL
Ε	MASONRY - 3,000 PSI MIN. CONCRETE CONFORMING TO ACI 301 OR HOLLOW BLOCK CONFORMING TO ASTM C90	CONCRETE
F	1/4" X 3-3/4" PFH ELCO OR ITW CONCRETE SCREW	STEEL
G	3/16" x 3-1/4" PFH ITW CONCRETE SCREW	STEEL
1	1/4" X 1-3/4" PFH ELCO OR ITW CONCRETE SCREW	STEEL
J	#10 X 2" PFH WOOD SCREW	STEEL
L	#10 X 2-1/2" PFH WOOD SCREW (1.15" MIN. EMB.)	STEEL
М	3/16" X 2-1/4" ITW CONCRETE SCREW	STEEL
N	3/16" X 2-3/4" ITW CONCRETE SCREW	STEEL
Р	1/4" X 2-1/4" PFH ELCO CONCRETE SCREW	STEEL
1	POLY FIBER JAMB	COMP.
6	DOOR SWEEP	PVC
7	WEATHERSTRIP (ENDURA FORCE 5)	FOAM
8	WEATHERSTRIP (Q-LON)	FOAM
9	#9 x 3/4" PFH WOOD SCREW	STEEL
11	4" X 4" HINGE	STEEL
12	LATCH STRIKE PLATE	STEEL
13	DEADBOLT STRIKE PLATE	STEEL
20	INSWING THRESHOLD	ALUM/COMP
21	INSWING THRESHOLD W/ SIDELITE ADAPTER	ALUM/COMP
22	OUTSWING THRESHOLD	ALUM/COMP
23	OUTSWING THRESHOLD W/ SIDELITE ADAPTER	ALUM/COMP
24	ADA THRESHOLD	ALUM
25	OUTSWING THRESHOLD	ALUM/WOOD
26	INSWING THRESHOLD	ALUM/WOOD
27	INSWING THRESHOLD W/ SIDELITE ADAPTER	ALUM/WOOD
33	ASTRAGAL (DLP OR ENDURA)	ALUM
40	DOOR PANEL	
50	SIDELITE PANEL	**


### **CONCRETE ANCHOR NOTES:**

- Concrete anchor locations at the comers may be adjusted to maintain the min. edge distance to mortar joints.
- Concrete anchor locations noted as "MAX. ON CENTER" must be adjusted to maintain the min. edge distance to mortar joints, additional concrete anchors may be required to ensure the "MAX. ON CENTER" dimension are not exceeded.
- 3. Concrete anchor table:

	ANCHOR		MIN. CLEARANCE TO MASONRY	MIN. CLEARANCE TO ADJACENT
TYPE	SIZE	EMBEDMENT	EDGE	ANCHOR
ITW BUILDEX	3/16"	1-1/4"	3"	1-1/2"
TAPCON®	1/4"	1-1/4"	2"	4"
ELCO ULTRACON <sup>®</sup>	1/4"	1-1/4"	1"	4"

### **WOOD SCREW INSTALLATION NOTES:**

 Maintain a minimum 5/8" edge distance, 1" end distance, & 1" o.c. spacing of wood screws to prevent the splltting of wood.

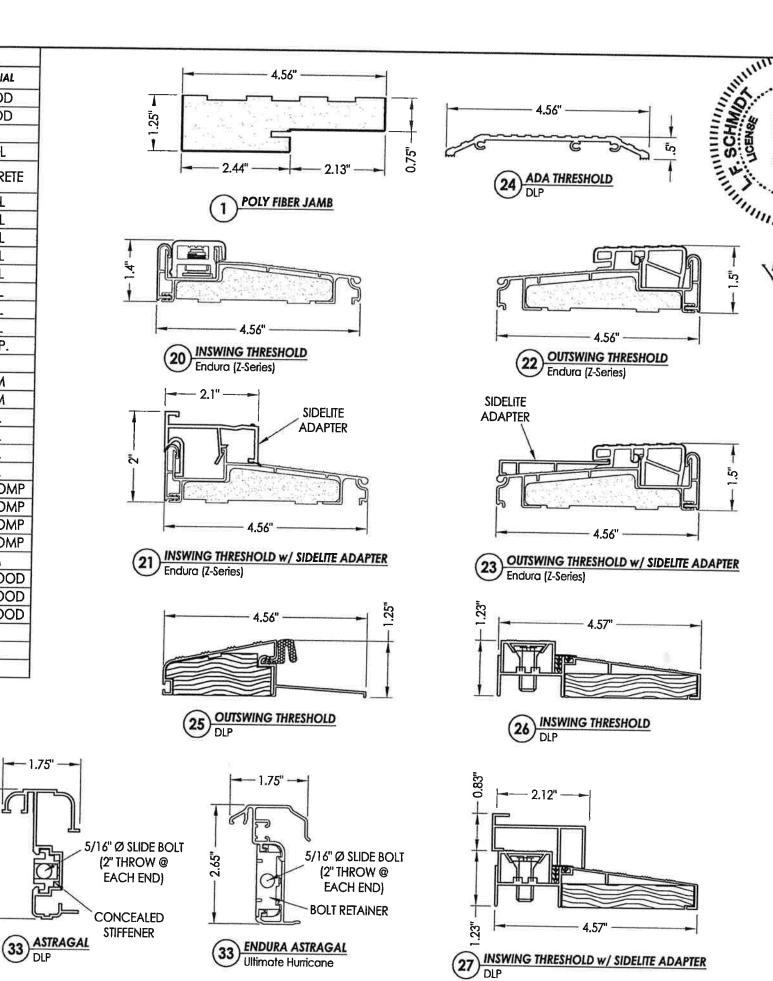

Lyndon P.E. No.

PLASTPRO INC FIBERGLASS DOOR

DATE: 10/08/14

FL-17347.2

SHEET 12 OF 12

N.T.S.

JK

LFS

SCALE:

OWG. BY:

CHK, BY:

DRAWING NO.:

OF MATERIALS COMPONENTS

BIL

JONATHAN ZACHEM, SECRETARY



### STATE OF FLORIDA DEPARTMENT OF BUSINESS AND PROFESSIONAL REGULATION

### CONSTRUCTION INDUSTRY LICENSING BOARD

THE RESIDENTIAL CONTRACTOR HEREIN IS CERTIFIED UNDER THE PROVISIONS OF CHAPTER 489, FLORIDA STATUTES

### OCHSTEIN, SAMUEL ELI

NEWSOUTH WINDOW SOLUTIONS, LLC 10741 CROSSROADS COMMERCE BLVD TAMPA FL 33610

LICENSE NUMBER: CRC1330822

**EXPIRATION DATE: AUGUST 31, 2020** 

Always verify licenses online at MyFloridaLicense.com



Do not alter this document in any form.

This is your license. It is unlawful for anyone other than the licensee to use this document.

### **CITY OF ALTAMONTE SPRINGS**

225 NEWBURYPORT AVENUE ALTAMONTE SPRINGS, FLORIDA 32701-3697 407-571-8116

NEW SOUTH WINDOW SOLUTIONS OF ORLANDO LLC **HOLLY HOLMBERG 820 E ALTAMONTE DR ALTAMONTE SPRINGS, FL 32701-5002** 

### DO NOT PAY - THIS IS NOT A BILL Below Certificate must be displayed at Business Location



### CITY OF ALTAMONTE SPRINGS

225 NEWBURYPORT AVENUE **ALTAMONTE SPRINGS, FLORIDA 32701-3697** 407-571-8116

Fiscal Year 2018-2019

### **BUSINESS TAX RECEIPT**

**Business Number:** 

28746

Expires: September 30, 2019

**Business Name:** 

NEW SOUTH WINDOW SOLUTIONS OF ORLANDO LLC

**HOLLY HOLMBERG** 

**Business Address:** 

820 E ALTAMONTE DR

**ALTAMONTE SPRINGS, FL 32701** 

RECEIPT NO.	CLASS DESCRIPTION	FEE
BTR-002928-2019	Seminole County - Regulated	\$45.00
BTR-002928-2019	Contractor - All others/State Licensed	\$120.75
TOTAL BUSINESS T	AX PAID:	\$165.75

Restrictions:

None

### NEWSOUT

 $ACORD_{\shortparallel}$ 

### CERTIFICATE OF LIABILITY INSURANCE

DATE (MM/DD/YYYY) 04/17/2018

THIS CERTIFICATE IS ISSUED AS A MATTER OF INFORMATION ONLY AND CONFERS NO RIGHTS UPON THE CERTIFICATE HOLDER. THIS CERTIFICATE DOES NOT AFFIRMATIVELY OR NEGATIVELY AMEND, EXTEND OR ALTER THE COVERAGE AFFORDED BY THE POLICIES BELOW. THIS CERTIFICATE OF INSURANCE DOES NOT CONSTITUTE A CONTRACT BETWEEN THE ISSUING INSURER(S), AUTHORIZED REPRESENTATIVE OR PRODUCER, AND THE CERTIFICATE HOLDER.

IMPORTANT: If the certificate holder is an ADDITIONAL INSURED, the policy(les) must be endorsed. If SUBROGATION IS WAIVED, subject to the terms and conditions of the policy, certain policies may require an endorsement. A statement on this certificate does not confer rights to the certificate holder in lieu of such endorsement(s).

PRODUCER	NAME: Renee Brown				
Lanier Upshaw, Inc.	PHONE (A/C, No. Ext): 863 284-3139 (A/C, No):	863 682-6292			
1115 US Hwy 98 South	E-MAIL ADDRESS: Renee.Brown@lanierupshaw.com				
P.O. Box 468	INSURER(S) AFFORDING COVERAGE	NAIC#			
Lakeland, FL 33802	INSURER A : Security National Insurance Company	19879			
INSURED	INSURER B : Commerce & Industry Insurance Co.	19410			
NewSouth Window Solutions, LLC	INSURER C : Zenith Insurance Company	13269			
Doers Window Manufacturing, LLC	INSURER D : Markel American Insurance Co	28932			
10741 Crossroads Commerce Blvd,	INSURER E : Travelers Indomnity Company	25658			
Tampa, FL 33610	INSURER F :				

COVERAGES

CERTIFICATE NUMBER:

THIS IS TO CERTIFY THAT THE POLICIES OF INSURANCE LISTED BELOW HAVE BEEN ISSUED TO THE INSURED NAMED ABOVE FOR THE POLICY PERIOD INDICATED. NOTWITHSTANDING ANY REQUIREMENT, TERM OR CONDITION OF ANY CONTRACT OR OTHER DOCUMENT WITH RESPECT TO WHICH THIS

INDICATED. NOTWITHSTANDING ANY REQUIREMENT, TERM OR CONDITION OF ANY CONTRACT OR OTHER DOCUMENT WITH RESPECT TO WHICH THIS INDICATED. NOTWITHSTANDING ANY PERTAIN, THE INSURANCE AFFORDED BY THE POLICIES DESCRIBED HEREIN IS SUBJECT TO ALL THE TERMS, EXCLUSIONS AND CONDITIONS OF SUCH POLICIES. LIMITS SHOWN MAY HAVE BEEN REDUCED BY PAID CLAIMS.

NSR TR	TYPE OF INSURANCE	ADDL SUBR	POLICY NUMBER	(MM/DD/YYYY)	(MM/DD/YYYY)	LIMIT	8
A	CLAIMS-MADE X OCCUR		SES133405602	05/06/2018	05/06/2019	EACH OCCURRENCE DAMAGE TO RENTED PREMISES (Ea occurrence)	\$1,000,000 \$100,000
- 0	X BI/PD Ded:5,000				9	MED EXP (Any one person)	s Excluded
						PERSONAL & ADV INJURY	\$1,000,000
	GEN'L AGGREGATE LIMIT APPLIES PER:	1 1 1				GENERAL AGGREGATE	\$2,000,000
	POLICY X PRO-					PRODUCTS - COMP/OP AGG	\$2,000,000 \$
1	OTHER: AUTOMOBILE LIABILITY		BA1H03663418SEL	05/06/2018	05/06/2019	COMBINED SINGLE LIMIT (Ea accident)	s1,000,000
	X ANY AUTO					BODILY INJURY (Per person)	\$
- 1	ALL OWNED SCHEDULED AUTOS					BODILY INJURY (Per accident)	S
- 1	X HIRED AUTOS X NON-OWNED AUTOS					PROPERTY DAMAGE (Per accident)	\$
	XPIP					PIP	\$10,000
	UMBRELLA LIAB X OCCUR		BE079331931	05/06/2018	05/06/2019	EACH OCCURRENCE	\$4,000,000
	X EXCESS LIAB CLAIMS-MADE			ĺ		AGGREGATE	\$4,000,000
	DED X RETENTION \$0						\$
	WORKERS COMPENSATION AND EMPLOYERS' LIABILITY		Z133996702	02/15/2018	02/15/2019	X PER OTH-	
	ANY PROPRIETOR/PARTNER/EXECUTIVE			1	E.L, EACH ACCIDENT	\$1,000,000	
- 1	(Mandatory in NH)	N/A			113-0	E.L. DISEASE - EA EMPLOYEE	\$1,000,000
	If yes, describe under DESCRIPTION OF OPERATIONS below					E.L. DISEASE - POLICY LIMIT	\$1,000,000
П	Rented/Leased		MKLM3IM0049718	05/06/2018	05/06/2019	\$100,000 Per Item/O	cc
Equipment						\$1,000 Deductible	

DESCRIPTION OF OPERATIONS / LOCATIONS / VEHICLES (ACORD 101, Additional Remarks Schedule, may be attached if more space is required)

\*\* Supplemental Names \*\*

NewSouth Window Solutions of Orlando, LLC; NewSouth Window Solutions of Tampa Bay, LLC DBA: NewSouth Window Solutions of West Palm Beach, LLC; NewSouth Window Solutions of Ft. Lauderdale, LLC; Doers Installation Services, LLC; NewSouth Window Solutions of Jacksonville, LLC

Contractor: Samuel E. Ochstein #CRC1330822; Contractor: Stephen Lambert #SCC131151763

CERTIFICATE HOLDER	CANCELLATION
City of Belle Isle Attn: Contractors Licensing Dept 1600 Nela Ave.	SHOULD ANY OF THE ABOVE DESCRIBED POLICIES BE CANCELLED BEFORE THE EXPIRATION DATE THEREOF, NOTICE WILL BE DELIVERED IN ACCORDANCE WITH THE POLICY PROVISIONS.
Belle Isle, FL 32809	AUTHORIZED REPRESENTATIVE
r	Betsey D. Ginany