

Company Name: ESA Renewables LLC

CVC56979

407 915 5439

Contractor Name: Click, David

License Number:

Phone Number:

Address:

City of Belle Isle

Universal Engineering Sciences 3532 Maggie Blvd., Orlando, FL 32811 Tel 407-581-8161 * Fax 407-581-0313 * www.universalengineering.com

PERMIT CARD - PLEASE POST AT JOB SITE

THIS DOCUMENT BECOMES YOUR PERMIT WHEN PROPERLY VALIDATED

Per FBC 105.3.3: An enforcing authority may not issue a building permit for any building construction, erection, alteration, modification, repair or addition unless the permit either includes on its face or there is attached to the permit the following statement: "NOTICE: In addition to the requirements of this permit, there may be additional restrictions applicable to this property that may be found in the public records of this county, and there may be additional permits required from other governmental entities such as water management districts, state agencies, or federal agencies." The issuance of this permit does not grant permission to violate any

applicable City, Orange County, State of Florida and/or Federal codes and/or ordinances. Separate permits are required for Signs, Roofing, Electrical, Gas, Plumbing and Mechanical services. This permit becomes VOID if the work authorized is not commenced within 6 months, or is suspended or abandoned for a period of 6 months after commencement. WORK SHALL BE CONSIDERED SUSPENDED IF AN APPROVED INSPECTION HAS NOT BEEN MADE WITHIN A 6 MONTH PERIOD. PERMISSIO IS GRANTED TO DO THE FOLLOWING WORK ACCORDING TO THE CONDITIONS HEREON AND THE APPROVED PLANS AND SPECIFICATIONS, SUBJECT TO COMPLIANCE WITH THE ORDINANCES OF THE CITY OF BELLE ISLE, FLORIDA. Scope of Work: ELECTRICAL: one photovoltaic system Permit Number: 2017-04-003 Date of Application: 03/30/2017 Comments: Date Permit Issued: 04/11/2017 **Project Information** WARNING TO OWNER: "YOUR FAILURE TO RECORD A 2624 Homewood Dr, Belle Isle, FL 32809 Address: NOTICE OF COMMENCEMENT MAY RESULT IN YOU Parcel ID: 19-23-30-5888-06-071 Kennedy, Charlene & John Property Owner: Phone Number: 407 855 7684

PAYING TWICE FOR IMPROVEMENTS TO YOUR PROPERTY. IF YOU INTEND TO OBTAIN FINANCING, CONSULT WITH YOUR LENDER OR AN ATTORNEY RECORDING BEFORE YOUR NOTICE COMMENCEMENT." ON THE JOB INSPECTION(S) MUST BE MADE BEFORE PROCEEDING WITH SUBSEQUENT WORK. THIS CARD MUST BE DISPLAYED OUTSIDE AND 4155 St. John's Parkway, Sanford, FL 32771 BE PROTECTED FROM THE WEATHER WHILE BEING VISIBLE FROM THE STREET UNTIL THE FINAL

INSPECTIONS HAVE BEEN APPROVED.

	BUILDING FEATURES
IMPACT FEES School \$	BUILDING INSPECTOR USE ONLY
Traffic \$	IF APPLICABLE: Have Zoning Approval Conditions Been Met? YES NO Have Stormwater Approval Conditions
ZONING FEES Zoning Fee \$	Been Met? YES NO Silt fencing in place? YES NO Turbidity Barrier in place? YES NO
UNIVERSAL ENG - BUILDING FEES	BUILDING 1st (Footing/Foundation)
Cert of Occ \$	Survey specific foundation plan must be onsite before slab pour. Approved Plan on Site?
Demo \$ Building \$	2 nd (Slab)
Fence \$ Driveway \$ Shed \$	3 rd (Lintel)(Wall Reinforcing on Masonry Building)
Window(s) \$ Door(s) \$	4 th (Exterior Framing)(Roof/Wall Sheathing)
PrePower \$ Electrical \$402.00	5 th (Framing) (To be made after Plumbing/ Mechanical/ Electrical Rough-Ins & Windows/Doors Installed)
Temp Pole \$ Plumbing \$	6 th (Insulation to be Made After Roof Installed)
Mechanical \$ Gas \$ Roofing \$	7 th (Drywall)
Boat Dock \$ Screen Encl \$	8 th (Sidewalk/Driveway)
Swimming Pool \$ Sign \$	9 th (Other)
SURCHARGE FEES	10 th (Final – After MEP and Other Applicable Finals)
Surcharge Fee \$6.03 Surcharge Fee \$6.03	ROOFING 1 ST ROOFING Deck Nailing/Dry-in/Flashing
-	2 nd ROOFING Covering In-Progress
TOTAL FEES \$414.06	3 rd ROOFING Covering Final
Date Paid + 17	☐ PLUMBING (Pool-Piping, Solar, Irrigation, Water Treatment Equip, Etc)
CC or Check #USA 8506	1 ST (Underground) 2 nd (Sewer)
Amount Paid 414-06	3 rd (Rough-In/Tub Set) 4 th (Final)
The person accepting this permit shall conform to the terms of the application on file and construction	CHECK APPROPRIATE BOX GASNaturalLP
shall conform to the requirements of the Florida Building Code (FS 553).	1 st (Rough-In) 2 nd (Final)

Inspection requests are to be emailed to BIDscheduling@UniversalEngineering.com; a confirmation email will be sent back to you upon scheduling. Next-Day Inspection requests must be made by 4pm. Please include the following in your request: Permit #, project address, type of inspection, date of the requested inspection, a contact name & a contact phone number. AM or PM may be requested but cannot be guaranteed.



City of Belle Isle
Universal Engineering Sciences 3532 Maggie Blvd., Orlando, FL 3281
Tel 407-581-8161 * Fax 407-581-0313 * www.universalengineering on

APPLICATION FOR ELECTRICAL PERMIT

WARNING TO OWNER: YOUR FAILURE TO RECORD A NOTICE OF COMMENCEMENT MAD RESULT IN YOUR PAYING TWICE FOR IMPROVEMENTS TO YOUR PROPERTY. A NOTICE OF COMMENCEMENT MUST BE RECORDED AND POSTED ON THE JOB SITE BEFORE THE FIRST INSPECTION. IF YOU INTEND TO OBTAIN FINANCING, CONSULT WITH YOUR LENDER OR AN ATTORNEY BEFORE RECORDING YOUR NOTICE OF COMMENCEMENT.

	DATE OF APPLICATION: 3/29/2017	PERMIT NUM	WBER 201-04-00 S
	The undersigned hereby applies for a permit to make electr	rical installations as indicated below.	PLEASE PRINT
	Project Address 2624 Homewood Dr 2624 Ho M	kward Dr	lle Isle FL
	Property Owner Charline Kennedy Kennedy	Charlie Pho	one (407) 855-7684 467-855-768 4
	Property Owner's Mailing Address 2624 Homewood Dr	City	y belle Işle
		Number: 30-5888 95-674 (C) Sain this information, please visit http://www	1-23-30-5868-06-071
	Class of Building: Old ☑ New ☐ Type of Build Type of Work: New ☑ Alteration ☐ Addition ☐	ing: Residentia Commercial Commercial Low Voltage	
	INDICATE THE QUANTITY	OF ALL EQUIPMENT TO BE INS	TALLED
	Dishwasher Exhaust Fan Hood Fan Dryer	Disposal Paddle Fan	
	Fixtures Spa	Paddie Fan Pool	
		Low Voltage	Switches Stoves
	Pumps Motors	Air Conditioning (tons)	Furnace (KW)
	Temporary Construction PoleOne		
	Meter Service Upgrade from Amperage/Voltage/Phase	to Amperage/Voltage/Phase	= Difference in Size
	Relocate Existing Meter Service (No Service Size Change)		
	Other: This permit application is for the installation of a photovoltaic solar s	system. Photovol-	taic solar system
	PERMIT FEE BASED ON METER SERVICE SIZE SCHE (IF NO METER SERVICE WORK BEING DONE, USE VA	EDULE ALUATION OF JOB FOR PERMIT F	. \$
	VALUATION OF JOB (VALUATION OF ALL MATERIALS		
			Permit Fee = \$ 268
	Building Official: Da	ite 4-10-17	Review Fee = \$ 134
	Verified Contractor's Licenses & Insurance are on file	Date 4-W.N	3% FL Surcharge = \$
	ned NOE Read		TOTAL Permit = \$ 414-06
	I hereby certify that the above is true and correct to the best o	of my knowledge.	
	I hereby make Application for Permit as outlined above, and if same	e is granted I agree to conform to all Flo	orida Building Code Regulations and City
	Ordinances regulating same and in accordance with plans submitte applicable Town and/or State of Florida codes and/or ordinances.	d. The issuance of this permit does not	t grant permission to violate any
	LICENSE HOLDER SIGNATURE	LICEN	SE # CVC56979 CVC56 4 19
	LICENSE HOLDER NAME David Click DAVID CL	COMPANY NAME ESAR	Ronewables LLC ESA Renewables LLC
	Street Address 4155 St. Johns Parkway 4155 ST. J	Dins Pkuy	
	City Sanford State FI Ernail Address Dclick@esarenewables.com	Zip Code <u>32771</u> Phone	407-915-5439 407-915-5439
	NOTE: The Building Permit Number is required if the Electrical In:	stallation is associated with any constru	uction or alteration where a Building
	Permit has been issued. IST IK 37		
	VICT (4)	Building Permit No	umber
Janca	Jan. 134_	-	
κ	TATIL		

		TO MITTALL AND A METERS AND A M
Dronarad hu	x17-04-003	DOC# 20170115554 03/06/2017 08:09:16 AM Page 1 of 1
Prepared by.		Rec Fee: \$10.00

Poturn to:		Orange County, FL MB - Ret To: ESA RENEWABLES LLC
Kelum lo.		MARTIN MATTER DAME CAME LAND A PROPERTY MATTER MARTIN
	B	
		
A.	NOTICE OF COMMEN	SEMENT
ail. revision	NOTICE OF COMMEN	LIVIENI
State of Florida, Cour		
		ent will be made to certain real property, and in accordance
		rmation is provided in this Notice of Commencement. property, and street address if available)
NEL A ISLETISI	AND SECTION 0/99 THE W/ 1	5 FT OF LOT 7 & E 70 FT LOT 8 & LAND ON S
	ion of improvement	STY OF LOTT & E TOTT LOT G & E MAD ON G
	otovoltaic solar system	18.0
3. Owner information	on or Lessee information if th	e Lessee contracted for the improvement
Name Kennedy J	ohn J Kennedy Charline	
Address 2624 Ho	mewood Dr Belle Isle, FL 3280)9-6113 <u>y</u> % -
Interest in Proper	ty owner	2 1
Name and addre	ss of fee simple titleholder (i	f different from Owner listed above)
		<u> </u>
Address		
. Contractor		
Name ESA Rene	wables LLC	Telephone Number 407-915-5430
Address 4155 St.	Johns Parkway, sanford, fl 327	Telephone Number 407-915-5430
. Carety (ii applicat	no, a copy of the paymont bond	a to ditability
Name	740	Telephone Number
	William (Amount of Bond \$
6. Lender	18	
		Telephone Number
Address		
		d by Owner upon whom notices or other documents m
be served as pro	ovided by §713.13(1)(a)7, Flor	
		Lelennone Nilmner
Name		Telephone Number
Name Address		
Name Address	mself or herself, Owner desig	gnates the following to receive a copy of the Lienor's
Name Address		nates the following to receive a copy of the Lienor's statutes.
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Name Address 8. In addition to his Notice as provid Name Address 9. Expiration date unless a different NING TO OWNER: ANY I CONSIDERED IMPROPE JILT IN YOUR PAYING TV ORDED AND POSTED ON I YOUR LENDER OR AN OTHER OF THE STATE O	mself or herself, Owner designed in §713.13(1)(b), Florida Sold of notice of commencement to date is specified) PAYMENTS MADE BY THE OWNER OF PAYMENTS UNDER CHAPTER 71. WICE FOR IMPROVEMENTS TO YOUN THE JOB SITE BEFORE THE FIRST ATTORNEY BEFORE COMMENCING OF Owner's or Lessee's Authorized Officer Owner's or Lessee's Authorized Officer Owner's Officer Commencement of Commencement	Telephone Number Telephone Number (the expiration date will be 1 year from the date of recording AFTER THE EXPIRATION OF THE NOTICE OF COMMENCEMENT 3, PART I, SECTION 713.13, FLORIDA STATUTES, AND CAN R PROPERTY. A NOTICE OF COMMENCEMENT MUST BE TINSPECTION. IF YOU INTEND TO OBTAIN FINANCING, CONSULT OF WORK OR RECORDING YOUR NOTICE OF COMMENCEMENT. Signatory's Title/Office Signatory's Title/Office
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SUNNY BOY 3.0-US / 3.8-US / 5.0-US / 6.0-US / 7.0-US / 7.7-US





Value-Added Improvements

- World's first Secure Power Supply now offers up to 2,000 W
- Full grid management capabilities ensure a utility-compliant solution for any market

Reduced Labor

- New Installation Assistant with direct access via smartphone minimizes time in the field
- Integrated disconnect simplifies equipment stocking and speeds

Unmatched Flexibility

- SMA's proprietary OptiTrac™
 Global Peak technology mitigates
 shade with ease
- Multiple independent MPPTs accommodate hundreds of stringing possibilities

Trouble-Free Servicing

- Two-part enclosure concept allows for simple, expedited servicing
- Enhanced AFCI technology reduces false tripping while improving sensitivity in real arcs

SUNNY BOY 3.0-US / 3.8-US / 5.0-US / 6.0-US / 7.0-US / 7.7-US

Reduce costs across your entire residential business model

The residential PV market is changing rapidly, and we understand that your bottom line matters more than ever. That's why we've designed a superior residential solution that will help you decrease costs throughout all stages of your business operations. The Sunny Boy 3.0-US/3.8-US/5.0-US/6.0-US/7.0-US/7.7-US join the SMA lineup of field-proven solar technology backed by the world's #1 service team, along with a wealth of improvements. Simple design, improved stocking and ordering, value driven sales support and streamlined installation are just some of the ways that SMA is working to help your business operate more efficiently.

www.SMA-America.com

Technical data	Sunny B	oy 3.0-US	Sunny B	oy 3.8-US	Sunny B	oy 5.0-US
	208 V	240 V	208 V	240 V	208 V	240 V
Input (DC)						
Max. usable DC power	3100 W	3100 W	3450 W	4000 W	5150 W	5150 W
Max. DC voltage			60	00 V		
Rated MPP voltage range	155 -	480 V	195 -	480 V	220 -	480 V
MPPT operating voltage range			100 -	- 550 V		
Min. DC voltage / start voltage			100 V	/ 125 V		
Max. operating input current per MPPT			19	0 A		
Max. short circuit current per MPPT			1-	8 A		
Number of MPPT tracker / string per MPPT tracker		2	/1		3	/ 1
Output (AC)						
AC nominal power	3000 W	3000 W	3330 W	3800 W	5000 W	5000 W
Max. AC apparent power	3000 VA	3000 VA	3330 VA	3800 VA	5000 VA	5000 VA
Nominal voltage / adjustable	208 V / ●	240 V / •	208 V / •	240 V / •	208 V / •	240 V / ●
AC voltage range	183 - 229 V	211 - 264 V	183 - 229 V	211 - 264 V	183 - 229 V	211 - 264
AC grid frequency			60 Hz	/ 50 Hz		
Max. output current	14.5 A	12.5 A	16.0 A	16.0 A	24.0 A	24.0 A
Power factor (cos φ)				1		24.071
Output phases / line connections			1	/2		
Harmonics				4 %		
Efficiency				4 70		
Max. efficiency	97.2 %	97.6 %	97.2 %	97.5 %	97.2 %	97.5 %
CEC efficiency	96 %	96.5 %	96.5 %	96.5 %	96.5 %	97.3 % 97 %
Protection devices	70 /4	70.5 76	70.5 78	70.5 /6	70.5 %	7/ /0
DC disconnect device						
DC reverse polarity protection						
Ground fault monitoring / Grid monitoring						
AC short circuit protection						
All-pole sensitive residual current monitoring unit (RCMU)				•		
Arc fault circuit interrupter (AFCI)						
Protection class / overvoltage category				′IV		
General data			1/	IV		
Dimensions (W / H / D) in mm (in)			525 720 100	(01.1 00.5 7.0)		
Packaging Dimensions (W / H / D) in mm (in)				$(21.1 \times 28.5 \times 7.8)$		
Weight			-	23.6 x 31.5 x 11.8)		
Packaging weight			_	(57 lb)		
			•	(66 lb)		
Operating temperature range Noise emission (typical)				+60°C		
171 .				B(A)		
Internal power consumption at night				5 W		
Topology				rmerless		
Cooling concept			Conv	ection		
Features						
Secure Power Supply				•		
Display (2 x 16 characters)			-			
Interfaces: Ethernet / WLAN				·		
Sensor module / External WLAN antenna				/ 0		
Warranty: 10 / 15 / 20 years				0/0		
Certificates and approvals	UL 174	1, UL 1998, UL 169	9B, IEEE1547, FCC	Part 15 (Class A & B)	, CAN/CSA V22.2 1	07.1-1
 Standard features O Optional features - Not av 		ominal conditions				
Type designation	SB3.0-13	SP-US-40	SB3.8-1	SP-US-40	SB5.0-13	SP-US-40








External WLAN antenna EXTANT-US-40



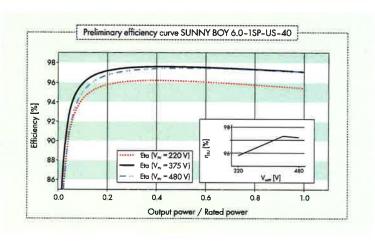

Technical data	-	oy 6.0-US	•	oy 7.0-US	Sunny B	oy 7.7-US
Land (DC)	208 V	240 V	208 V	240 V	208 V	240 V
Input (DC)						
Max usable DC power	5400 W	6200 W	6900 W	7200 W	6900 W	7950 W
Max. DC Voltage			60	00 V		
Rated MPP Voltage range	220 -	- 480 V	245 -	480 V	270 -	480 V
MPPT operating voltage range			100 -	- 550 V		
Min. DC voltage / start voltage			100 V	/ 125 V		
Max. operating input current per MPPT				0 A		
Max. short circuit current per MPPT			1:	8 A		
Number of MPPT tracker / string per MPPT tracker			3	/1		
Output (AC)				,		
AC nominal power	5200 W	6000 W	6660 W	7000 W	6660 W	7680 W
Max. AC apparent power	5200 VA	6000 VA	6660 VA	7000 VA	6660 VA	7680 VA
Nominal voltage / adjustable	208 V / •	240 V / •	208 V / •	240 V / ●	208 V / •	240 V /
AC voltage range	183 - 229 V	211 - 264 V	183 - 229 V	211 - 264 V	183 - 229 V	211 - 264
AC grid frequency	227 .	211 204 (/ 50 Hz	103 - 227 ¥	211 - 204
Max. output current	25.0 A	25.0 A	32.0 A	29.2 A	32.0 A	32.0 A
Power factor (cos φ)	20.071	20.070		1	32.0 A	32.0 A
Output phases / line connections				/2		
Harmonics				7		
Efficiency				4 /0		
Max. efficiency	97.2 %	97.6 %	97.1 %	97.5 %	07.1.9/	07.5%
CEC efficiency	96.5 %	97.0 % 97 %	96.5 %	97.3 % 97 %	97.1 %	97.5 %
Protection devices	70.5 %	77 /0	90.J /o	9/ %	96.5 %	97 %
DC disconnect device						
DC reverse polarity protection						
Ground fault monitoring / Grid monitoring				•		
AC short circuit protection						
All-pole sensitive residual current monitoring unit (RCMU)						
				•		
Arc fault circuit interrupter (AFCI)				•		
Protection class / overvoltage category			17	' IV		
General data						
Dimensions (W / H / D) in mm (in)				$(21.1 \times 28.5 \times 7.8)$		
Packaging Dimensions (W / H / D) in mm (in)				23.6 x 31.5 x 11.8)		
Weight			_	(57 lb)		
Packaging weight			_	(66 lb)		
Operating temperature range			- 25°C	+60°C		
Noise emission (typical)	36 c	B(A)		45 d	lB(A)	
Internal power consumption at night			< 5	5 W		
Topology			Transfo	rmerless		
Cooling concept	Conv	ection		Fo	n	
Features						
Secure Power Supply			•			
Display (2 x 16 characters)				•		
Interfaces: Ethernet / WLAN			•	/ ●		
Sensor module / External WLAN antenna			0,	/ 0		
Warranty: 10 / 15 / 20 years			•/0	0/0		
Certificates and approvals	UL 174	11, UL 1998, UL 169		Part 15 (Class A & B)	, CAN/CSA V22.2 1	07.1-1
 Standard features — O Optional features — Not ave 			NOTE: US inverters s			
Type designation	SB6.0-13	SP-US-40		SP-US-40	SB7.7-15	SPLIS 40



SAME NAME, NEW GAME

The Sunny Boy 3.0-US through 7.7-US are once again raising the bar by offering improved performance, enhanced features, and most importantly, an economical approach to residential solar. Your business model is a value chain. The new Sunny Boy-US series can help you stay competitive in an increasingly price sensitive residential market by driving down costs across all of your business operations.





SIMPLE, FLEXIBLE DESIGN

Speed the completion of customer proposals and maximize the efficiency of your design team with the Sunny Boy-US series, which provides a new level of flexibility in system design by offering:

- » Hundreds of stringing configurations and multiple independent MPPTs
- » SMA's proprietary OptiTrac™ Global Peak shade mitigation technology
- » Diverse application options including on- and off-grid compatibility



VALUE-DRIVEN SALES ENABLEMENT

Reviewed for Code Compliance Universal Engineering

SMA wants to enable your sales team by arming them with an abundance of feature/ benefit support. Show your customers the value of the Sunny Boy-US series by utilizing:

- » Secure Power Supply, now with 2,000 W of opportunity power in the event of a grid outage, as an increased value-add or upsell opportunity
- » SMA's 35 year history and status as the #1 global inverter manufacturer instills homeowners with peace of mind and the long-term security they demand from a PV investment
- » An economical solution for shade mitigation and the challenges of complex roofs



Ensure that your back office business operations run smoothly and succinctly while mitigating potential errors. The Sunny Boy-US series can help achieve cost savings in these areas by providing:

- An integrated DC disconnect that simplifies equipment stocking and allows for a single inverter part number
- » All communications integrated into the inverter, eliminating the need to order additional equipment



STREAMLINED INSTALLATION AND COMMISSIONING

Expedite your operations in the field by taking advantage of the new Sunny Boy's installer-friendly feature set including:

- » Direct access via smartphone and utilization of SMA's Installation Assistant, which minimizes time/labor spent in the field and speeds the path to commissioning
- » Improved communication—no need to install additional equipment
- Integrated DC disconnect that simplifies onsite logistics and eliminates the need to install a separate disconnect unit, speeding overall installation time



SUPERIOR SERVICE

SMA understands the factors that contribute to lifetime PV ownership cost, that's why the Sunny Boy-US series was designed for maximum reliability and backstopped by an unmatched service offering. Benefit from:

- The new Sunny Boy's two-part enclosure concept that separates the connection unit from the power unit, which allows for simple, expedited servicing
- The #1 service team in the PV industry, as recognized by IMS research, with experience servicing an installed base of more than 40 GW

Hyundai Solar Modu

APR 10 2017



Hyundai Heavy Industries was founded in 1972 and is a Fortune 500 company. The company employs more than 48,000 people, and has a global leading 7 business divisions with sales of 51.3 Billion USD in 2013. As one of our core businesses of the company, Hyundai Heavy Industries is committed to develop and invest heavily in the field of renewable energy.

Hyundai Solar is the largest and the longest standing PV cell and module manufacturer in South Korea. We have 600 MW of module production capacity and provide high-quality solar PV products to more than 3,000 customers worldwide. We strive to achieve one of the most efficient PV modules by establishing an R&D laboratory and investing more than 20 Million USD on innovative technologies.

PERL RG-Series

Multi-crystalline Type HiS-M265RG | HiS-M270RG | HiS-M275RG

Mono-crystalline Type HiS-S280RG | HiS-S285RG | HiS-S290RG

Mechanical Characteristics

* Several models are under certification process

Dimensions 998 mm (39.29")(W) × 1,640 mm (64.57")(L) × 35 mm (1.38")(H) Weight Approx. 18.7 kg (41.2 lbs) Solar cells 60 cells in series (6 ×10 matrix) with PERL technology (Hyundai cell, Made in Korea) 4 mm² (12AWG) cables with polarized weatherproof connectors, Output cables IEC certified (UL listed), Length 1.0 m (39.4") IP67, weatherproof, IEC certified (UL listed) Bypass diodes 3 bypass diodes to prevent power decrease by partial shade Front: Anti-reflective coating low-iron tempered glass, 3.2 mm (0.126") Encapsulant : EVA Back Sheet: Weatherproof film Clear anodized aluminum alloy type 6063 (Black)

High Quality

- IEC 61215 (Ed.2) and IEC 61730 by VDE
- UL listed (UL 1703), Type 1 for Class A Fire Rating
- Output power tolerance +3/-0 %
- ISO 9001:2000, ISO 14001:2004 and ISO 50001:2011 Certified
- OHSAS 18001:2007 Certified
- Advanced Mechanical Test (8,000 Pa) Passed (IEC) / Mechanical Load Test (40 lbs/ft²) Passed (UL)
- Ammonia Corrosion Resistance Test Passed
- IEC 61701 (Salt Mist Corrosion Test) Passed

Limited Warranty

- 1st year: 97 %
- After 2nd year: 0.7 % annual degradation 80.2 % for 25 years
- ▶ Please refer to the Hyundai Limited Warranty for more details.

*** Important Notice on Warranty**

The warranties apply only to the PV modules with Hyundai Heavy Industries Co., Ltd.'s logo (shown below) and product serial number on it,

















Electrical Characteristics

| Multi-crystalline Type |



			31 12	100
	10 IN	The second second	HIS-MICHERG	
		265	270	275
Nominal output (Pmpp)	W	265	270	275
Voltage at Pmax (Vmpp)	V	31.3	31.4	31.5
Current at Pmax (Impp)	A	8.5	8.6	8.7
Open circuit voltage (Voc)	V	37.9	38.0	38.2
Short circuit current (Isc)	Α	9.1	9.2	9.3
Output tolerance	%		+3/-0	
No. of cells & connections	pcs		60 in series	
Cell type	-	6" Multi-crystalline	silicon with PERL technology (Hyunda	ai cell, Made in Korea)
Module efficiency	%	16.2	16.5	16.8
Temperature coefficient of Pmpp	%/K	-0.41	-0.41	-0.41
Temperature coefficient of Voc	%/K	-0.32	-0.32	-0.32
Temperature coefficient of Isc	%/K	0.039	0.039	0.039


^{**}All data at STC (Standard Test Conditions). Above data may be changed without prior notice.

| Mono-crystalline Type |

THE ALL LAND STREET IN THE		HIS-SILITIRG		
		280	285	290
Nominal output (Pmpp)	w	280	285	290
Voltage at Pmax (Vmpp)	V	31.7	31.8	32.0
Current at Pmax (Impp)	A	8.8	8.9	9.1
Open circuit voltage (Voc)	V	38.5	38.7	38.8
Short circuit current (Isc)	A	9.4	9.5	9.7
Output tolerance	%		+3/-0	
No. of cells & connections	pcs		60 in series	
Cell type		6" Mono-crystalline s	ilicon with PERL technology (Hyund	ai cell, Made in Korea)
Module efficiency	%	17.1	17.4	17.7
Temperature coefficient of Pmpp	%/K	-0.42	-0.42	-0.42
Temperature coefficient of Voc	%/K	-0.30	-0.30	-0.30
Temperature coefficient of Isc	%/K	0.047	0.047	0.047


 $[\]hbox{\it \#All data at STC (Standard Test Conditions)}, Above data may be changed without prior notice, and the standard Test Conditions is a supplied to the standard Test Conditions of the stan$

| Module Diagram |

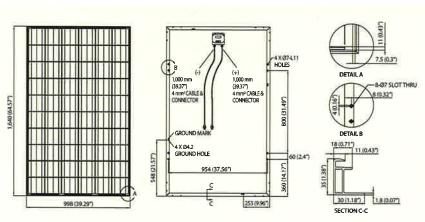


| I-V Curves |

(unit : mm, inch)

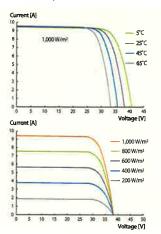

| Installation Safety Guide |

- Only qualified personnel should install or perform maintenance.
- Be aware of dangerous high DC voltage.
- Do not damage or scratch the rear surface of the module.
- Do not handle or install modules when they are wet.

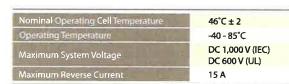



[Printed Date : December 2015]



Sales & Marketing Hyundai Bldg., 75, Yulgok-ro, Jongno-gu, Seoul 03058, Korea Tel : +82-2-746-4671, 7635, 8556 Fax : +82-2-746-7675



PROJECT DESCRIPTION:

40x285 HYUNDAI HEAVY INDUSTRIES HIS-S285RG (285W) ROOF MOUNTED SOLAR PHOTOVOLTAIC MODULES

SYSTEM SIZE: 11.40 kW DC STC ARRAY AREA #1: 422.88 SQ FT, ARRAY AREA #2: 281.92 SQ FT.

EQUIPMENT SUMMARY

40 HYUNDAI HEAVY INDUSTRIES HIS-S285RG (285W)

SHEET INDEX

PLOT PLAN & VICINITY MAP A-00 S-01 **ROOF PLAN & MODULES**

S-02 STRUCTURAL ATTACHMENT DETAILS

DS-01-03 DATA SHEET

GOVERNING CODES FLORIDA ELECTRIC CODE, 5TH EDITION 2014 EDITION (FEC) FLORIDA RESIDENTIAL CODE, 5TH EDITION 2014 (FRC)

FLORIDA PLUMBING CODE, 5TH EDITION 2014 (FPC) FLORIDA BUILDING CODE, 5TH EDITION 2014 EDITION (FBC) FLORIDA MECHANICAL CODE, 5TH EDITION 2014 (FMC) ARTICLE 690, NEC 2011 CODE BOOK





HOUSE PHOTO SCALE: NTS



VICINITY MAP



PROJECT SITES

KENNEDY 2624 HOMEWOOD DRIVE, BELLE ISLE, FL 32809 CHARLINE

PROJECT NAME

RC ENGINEERING, LLC

COA # 28:345
2381 CREST RIDGE COURT
SANFORD, FL 32771

TEL 407-474-9181ERMOCRATES E CASTILLO - FL PE 52590

REVISIONS

PROJECT DEVELOPER

DATE REV

DESCRIPTION

SHEET NAME **PLOT PLAN & VICINITY MAP**

> SHEET SIZE **ANSI B** 11" X 17"

SHEET NUMBER A-00

SCALE: NTS

EXISTING DRIVE WAY (24) HYUNDAI HEAVY INDUSTRIES HIS-S285RG (285W) ROOF #2 (16) HYUNDAI HEAVY INDUSTRIES HIS-S285RG (285W) 2-STORY HOUSE 19'-2"

HOMEWOOD DR,

96'-11"

PLOT PLAN WITH ROOF PLAN

A-00

SCALE: 1/32"=1'-0"

MODULE TYPE, DIMENSIONS & WEIGHT

NUMBER OF MODULES = 40 MODULES MODULE TYPE = HYUNDAI HEAVY INDUSTRIES HIS-S285RG (285W) MODULE WEIGHT = 41.2 LBS / 18.7 KG. MODULE DIMENSIONS = 64.57" x 39.29" = 17.62 SF UNIT WEIGHT OF ARRAY = 2.34 PSF

ARRAY & ROOF AREA

CALC'S (ROOF #1)

ARRAY AREA = 422.88 SQ. FT. ROOF FACE AREA = 837.00 SQ. FT. 422.88 / 837.00 = 50.52% OF ROOF FACE AREA COVERED BY ARRAY

DESCRIPTION (ROOF # 1)

ROOF TYPE - COMP SHINGLES ROOF TILT - 18.4° **ROOF AZIMUTH - 87°** RAFTER SIZE - 2"x4" @ 16" O.C.

ARRAY & ROOF AREA

CALC'S (ROOF #2)

ARRAY AREA = 281.92 SQ. FT. ROOF FACE AREA = 837.00 SQ. FT. 281.92 / 837.00 = 33.68% OF ROOF FACE AREA COVERED BY ARRAY

DESCRIPTION (ROOF #2)

ROOF TYPE - COMP SHINGLES ROOF TILT - 18.4° **ROOF AZIMUTH - 267°** RAFTER SIZE - 2"x4" @ 16" O.C.

> ROOF #2 TILT - 18.4° AZIM. - 267°

ROOF #2 (16) HYUNDAI HEAVY INDUSTRIES HIS-S285RG (285W)


(76) PV ROOF ATTACHMENT @ 48" O.C. MAX

(N) SNAPNRACK STD RAIL (TYP.)

WIND ZONE 2 (TYP.)

WIND ZONE 3 (TYP.)

(E) FRONT YARD

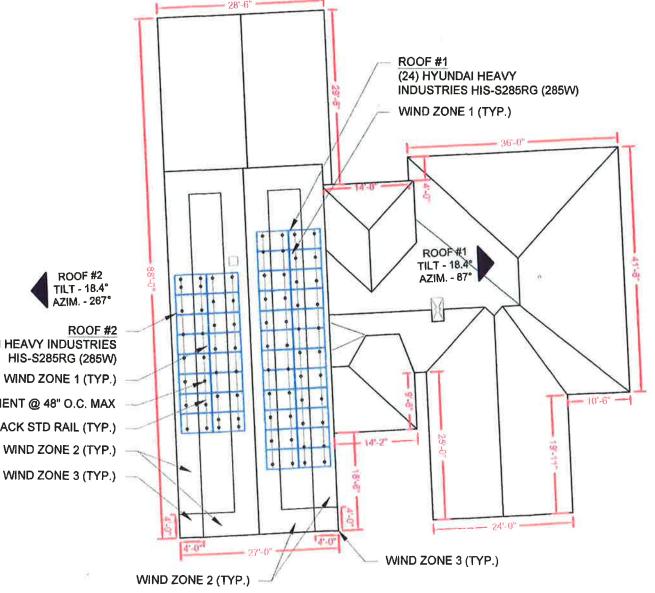

(E) BACK YARD

GENERAL INSTALLATION PLAN NOTES:

1) DRAWINGS SHOWN MAY NOT REFLECT FIELD CONDITIONS. CONTRACTOR TO FIELD VERIFY CONDITIONS PRIOR TO INSTALLATION.

2) CONTRACTOR MAY LOCATE PV MODULES TO DIFFERENT LOCATION THAN SHOWN, BUT SHALL NOT PLACE PV MODULES IN WIND ZONE 3.

3) ROOF ATTACHMENTS TO SYP TRUSSES SHALL BE INSTALLED AS SHOWN IN SHEET S-02 AND AS FOLLOWS FOR EACH WIND ZONE:

WIND ZONE 1: 4'-0" O.C. WIND ZONE 2: 4'-0" O.C.

WIND ZONE 3: NOT ALLOWED

SEE SHEET S-02 FOR SUPPORTING CALCULATIONS.

4) EXISTING RESIDENTIAL BUILDING IS ASSUMED TO BE A ASPHALT SHINGLE ROOF FINISH WITH MEAN ROOF HEIGHT LESS THAN 30 FT AND SYP 2X4 WOOD ROOF TRUSSES SPACED 16" O.C. EXISTING ROOF SLOPE FOR SOLAR SYSTEM RETROFIT IS ASSUMED TO BE BETWEEN 7 TO 27 DEGREES. CONTRACTOR TO FIELD VERIFY AND SHALL REPORT TO THE ENGINEER IF ANY DISCREPANCIES EXIST BETWEEN PLANS AND IN FIELD CONDITIONS.

10

64

- JUNCTION BOX

- SOLAR LOAD CENTER

- PRODUCTION METER

MAIN SERVICE PANEL

- PV ROOF ATTACHMENT

- INTEGRATED DC DISCONNECT

- VENT, ATTIC FAN (ROOF OBSTRUCTION)

- INVERTER

- RAFTERS

- CONDUIT

- COMBINER BOX

LEGEND

JB

INV

DC

SLD

PM

MSP

RC ENGINEERING, LLC COA # 28345 2381 CREST RIDGE COURT SANFORD, FL 32771

TEL: 407-474-9181ERMOCRATES E. CASTILLO - FL PE 52590 REVISIONS DESCRIPTION DATE REV

PROJECT DEVELOPER



Signature with Seal

PROJECT NAMI

KENNEDY

HYUNDAI HEAVY

INDUSTRIES

HIS-S285RG

(285W)

2624 HOMEWOOD DRIVE, BELLE ISLE, FL 32809 ENC CHARLINE PRESIDE

SHEET NAME

ROOF PLAN & MODULES


SHEET SIZE

ANSI B 11" X 17"

SHEET NUMBER

S-01



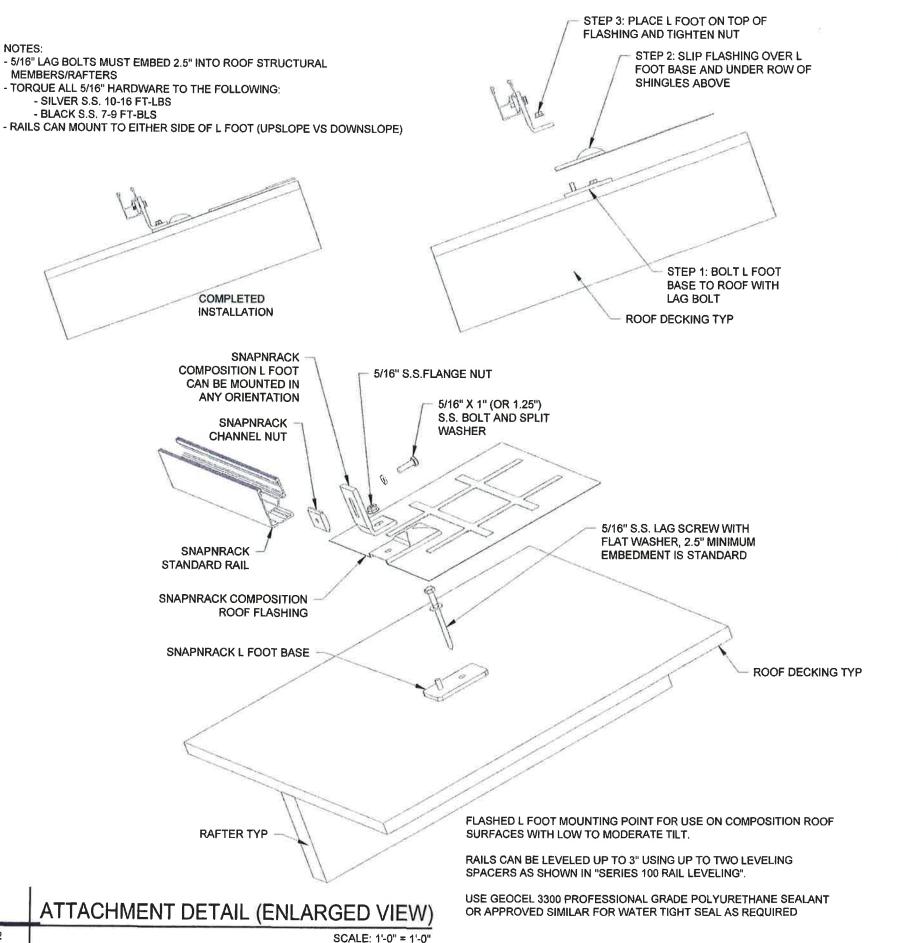

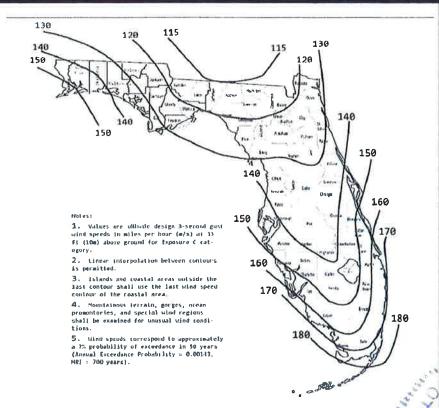


FIGURE 1609A ULTIMATE DESIGN WIND SPEEDS, VULT, FOR RISK CATEGORY II BUILDINGS AND OTHER STRUCTURES

Wind Speed Ult (mph)	140
Risk Category	11
Wind Speed ASD (mph)	110
Exposure Category	В
Mean Roof Height (ft)	25
Roof Slope (degrees)	20
Module Area (sq ft)	20
Kzt	1
Height Adjustment Factor, λ	1

Roof Zone	Pne	t (30)
1	11.4	-19.4
2	11.4	-31.9
3	11.4	-47.9

$P \text{ net} = \{\lambda K\} \text{ zt } P \text{ (net(30))}$

Roof Zone	Pr	et
1	11.4	-19.4
2	11.4	-31.9
3	11.4	-47.9



Ro	of Slope Cald	culator
Rise	Run	Slope (*)
4	12	18.4

Maximum Uplift per *fastener Wind Zone 1	213.4
Per American Wood Council - NDS Max	
Withdraw Load for 5/16"	476
LAG with 2.5"	
Embedment	

^{*} Roof attachements at 4' O/C w 2 rails

Maximum Uplift per *fastener Wind Zone 2	350.9
Per American Wood Council - NDS Max Withdraw Load for 5/16" LAG with 2.5" Embedment	476

^{*}Roof attachements at 4' O/C w 2 rails

Maximum Uplift per	263.5
*fastener Wind Zone 3	203.3
Per American Wood	
Council - NDS Max	
Withdraw Load for 5/16"	476
LAG with 2.5"	
Embedment	

^{*} Not allowed

RC ENGINEERING, LLC COA # 28345 2381 CREST RIDGE COURT SANFORD, FL 32771 TEL: 407-474-9181ERMOCRATES E. CASTILLO - FL PE 52590

REVISIONS						
DESCRIPTION	DATE	REV				
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PROJECT DEVELOPER



CHARLINE KENNEDY RESIDENCE 2624 HOMEWOOD DRIVE, BELLE ISLE, FL 32809

> SHEET NAME STRUCTURAL **ATTACHMENT DETAILS**

SHEET SIZE ANSI B 11" X 17"

SHEET NUMBER

S-02

SERIES 100 ROOF MOUNT SYSTEM

SnapNrack Residential PV Mounting Systems

The SnapNrack line of solar mounting systems is designed to reduce total installation costs. The system features technical innovations proven on more than 100MW of solar projects to simplify installation and reduce costs.

Pitched Roof Arrays Simplified

The SnapNrack Series 100 Roof Mount System is an efficient, visually appealing, photovoltaic (PV) module installation system. Series 100 was developed in the field by a team of veteran solar engineers and installers. Their goal was to ensure a quick, efficient installation. Series 100 has been tested on megawatts of real-world residential and commercial installations. Industry leading installation times are achieved with unique Snap-in fasteners and fully adjustable components that make installation of roof mounted solar arrays easy while achieving lower installation costs.


- Up to 3" of height adjustability at roof connection
- · Waterproof full-metal flashing at each roof penetration
- Works on virtually all composition and tile roofs
- Single wrench size for all system hardware
- Configures easily as low profile or tilt (0-60 Degrees)
- Rail channels provide excellent wire management



Roof System in 4 Simple Steps:

- I) Identify Site Conditions (Array Till, Building Height, Roof Type, Wind and Snow Loads)
- 2) Determine Footing Span from Engineering Tables (download at www.snapn/ack.com)
- Choose color (Clear or Black) and roof attachment type
- Place Order with your distributor. Purchase material for a single project or order in bulk for additional savings
- Rail & Module Clamps
- Roof Attachments
- Array Accessories



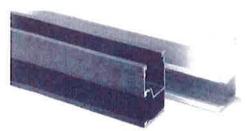





Simple

- · Quick assembly and clean aesthetic finish
- · One wrench fits every bolt in the system
- · Low profile installation on any roof

Adaptable

- Compatible with virtually all 60 and 72 cell modules
- Unique "snap-in" channel nuts can be installed anywhere on the rail
- Rail channels provide improved wire management

Strong

- Excellent seismic, wind, and snow-loading protection
- · Vertical and horizontal adjustments ensure superior flt
- · Rain-light metal flashing ensures waterproofing

Innovative Universal End Clamps

- One size fits any standard L frame module
- · Clean look nothing extends beyond module frames
- · Less waste rail lengths match most modules

	Snap Nrack Series 100 Technical Data Raina Penting		
Materials	• 6000 Series aluminum		
	Stainless steel		
	• Galvanized steel		
Material Finish	Clear and black anodized aluminum		
Installation • Quick and efficient mounting			
	Adjustable hardware to ensure clean and level finish		
	Worry-free waterproof flashing		
Calcs. & Certifications	 Wind speeds up to 150 MPH and snow loads to 120 PSF 		
Grounding	 Washer, Electrical Equipment Bond (WEEB) or lay-In lugs 		
Warranty	• 10 Year material and worksmanship (download full details at snapnrack.com)		



(877) 732-2860

www.SnapNrack.com

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RC ENGINEERING, LLC

COA # 28345

2381 CREST RIDGE COURT

SAMFORD, FL 32771

TEL 407-474-9181ERMOCRATES E.

CASTILLO - FL PE 525800

REVISIONS								
DESCRIPTION	DATE	REV						
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		-						

PROJECT DEVELOPER



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Signature with Sea



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CHARLINE KENNEDY RESIDENCE

HOMEWOOD DRIVE, LLE ISLE, FL 32809

2624 BEL

SHEET NAME

DATA SHEET

SHEET SIZE

ANSI B 11" X 17"

SHEET NUMBER

DS-01

Patent Pending










Series 100 Flashed L Foot Kit


SnapNrack Series 100 Flashed L Foot Kit is an innovative solution to provide a long lasting, watertight seal over the life of the system. The Flashed L Foot provides a fully flashed roof fastener for attachment to composition roof with no required cutting of shingles. The L Foot is engineered for maximum adjustability for a clean, level installation.

- Slotted attachment provides 1" vertical adjustability for array leveling
- 1" spacers available for increased elevation adjustability
- Offered in silver or black anodized aluminum. Both are available with black galvanized steel or aluminum flashing.
- No cutting of shingles

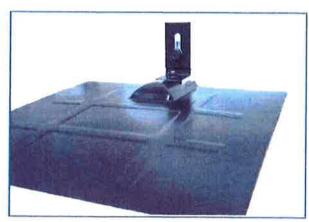


242-92051

Flashed L Foot Kit Assembly

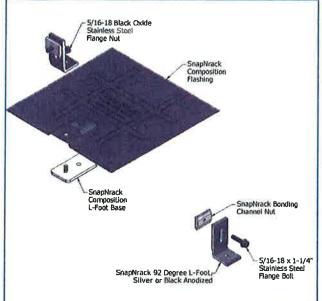

Flashed L Foot Kit Dimensions

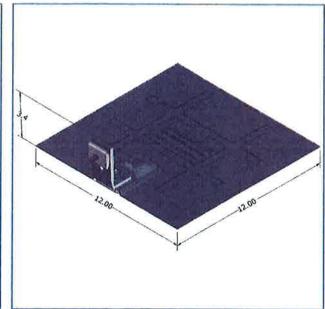

Features Include



Snap in











Easy



hardware





FLASHED L FOOT KIT TECHNICAL DATA

. 6000 Series aluminum L foot & base

Materials · Stainless steel hardware

Galvanized steel or aluminum flashing w/ black all weather coating

Material Finish Silver or black anodization

Design Uplift Load 340 lb

• Flange nut: 10-16 ft-lbs **Torque Specification**

• Rail attachment: silver hardware 10-16 ft-lbs, black hardware 8-10 ft-lbs

Reviewed for Code Compliance iversal Engineering

877-732-2860 www.snapnrack.com





contact@snapnrack.com

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RC ENGINEERING, LLC COA # 28345 2381 CREST RIDGE COURT TEL: 407-474-9161ERMOCRATES E. CASTILLO - FL PE 52590

REVISIONS DESCRIPTION DATE REV PROJECT DEVELOPER

32809 CHARLINE KENNEDY RESIDENCE 2624 HOMEWOOD BELLE ISLE, FL 3

> SHEET NAME DATA SHEET

> > SHEET SIZE

ANSI B 11" X 17"

SHEET NUMBER **DS-02**

Resources snapnrack.com/resources ... Design snapnrack.com/configurator ... Where to Buy snapnrack.com/where-to-buy



Hyundai Heavy Industries was founded in 1972 and is a Fortune 500 company. The company employs more than 48,000 people, and has a global leading 7 business divisions with sales of 51.3 Billion USD in 2013. As one of our core businesses of the company, Hyundai Heavy Industries is committed to develop and Invest heavily in the field of renewable energy.

Hyundai Solar is the largest and the longest standing PV cell and module manufacturer in South Korea. We have 600 MW of module production capacity and provide high-quality solar PV products to more than 3,000 customers worldwide. We strive to achieve one of the most efficient PV modules by establishing an R&D laboratory and investing more than 20 Million USD on innovative technologies.

PERL **RG-Series**

Multi-crystalline Type

HIS-M265RG | HIS-M270RG | HIS-M275RG

Mono-crystalline Type

HIS-S280RG | HIS-S285RG | HIS-S290RG

Mechanical Characteristics

50 year models are under certification process

. Olimphyons	998 mm (39.29°)(W) × 1,640 mm (
Whelite	Approx. 18.7 kg (41.2 lbs)
- Stimestic	60 cells in series (6 ×10 matrix) wit
Opposition sables	4 mm² (12AWG) cables with polaria IEC certified (UL listed), Length 1.0
(0) 6(0) (0)	IP67, weatherproof, IEC certified (L
Byrthytikakis	3 bypass diodes to prevent power
Cipatripaelien	Front : Anti-reflective coating low- Encapsulant : EVA Back Sheet
NAME OF TAXABLE PARTY.	

(64.57")(L) × 35 mm (1.38")(H)

rith PERL technology (Hyundai cell, Made in Korea)

rized weatherproof connectors,

.0 m (39,4")

UL listed)

decrease by partial shade

r-Iron tempered glass, 3.2 mm (0.126") : Weatherproof film

Clear anodized aluminum alloy type 6063 (Black)

Hadi Onlije

- · IEC 61215 (Ed.2) and IEC 61730 by VDE
- · UL listed (UL 1703), Type 1 for Class A Fire Rating
- Output power tolerance +3/-0 %
- ISO 9001:2000, ISO 14001:2004 and ISO 50001:2011 Certified
- OHSAS 18001:2007 Certified
- · Advanced Mechanical Test (8,000 Pa) Passed (IEC)
- / Mechanical Load Test (40 lbs/ft²) Passed (UL)
- · Ammonia Corrosion Resistance Test Passed · IEC 61701 (Salt Mist Corrosion Test) Passed

Lamter's Warranty

- 1st year: 97 %
- · After 2nd year: 0.7 % annual degradation 80.2 % for 25 years
- ▶ Please refer to the Hyundai Limited Warranty for more details.

Important Notice on Warranty

The warranties apply only to the PV modules yoth invandar Heavy industries Collectu's logo (shown below) and product social number on it.





The live of the record

| Multi-crystalline Type |


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				97
Nominal output (Pmpp)	w	265	270	275
Voltage at Pmax (Vmpp)	V	31.3	31.4	31.5
Current at Pmax (Impp)	٨	8.5	8.6	B.7
Open circuit voltage (Voc)	. v	37.9	38.0	38,2
Short circuit current (Isc)	Α	9.1	9.2	9,3
Output tolerance	96		+3/-0	
No. of cells & connections	pcs		60 in series	
Cell type	-	6"Multi-crystallines	silicon with PERL technology (Hyunda	i cell, Made in Korea)
Module efficiency	96	16.2	16.5	16.8
Temperature coefficient of Propp	96/K	-0.41	-0.41	-0.41
Temperature coefficient of Voc	96/K	-0.32	-0.32	-0.32
Temperature coefficient of lsc	96/K	0.039	0.039	0.039


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| Mono-crystalline Type |

TO STATE OF THE PARTY OF THE		COST CONTRACTOR OF THE PARTY.	Transfer equipments	
		191	Marine Company of the	dy later and the
Nominal output (Pmpp)	W	280	285	290
Voltage at Pmax (Vmpp)	V	31.7	31.8	32.0
Current at Pmax (Impp)	Α	8.8	8.9	9.1
Open circuit voltage (Voc)	V	38.5	38.7	38.8
Short circuit current (isc)	Α	9.4	9.5	9.7
Output tolerance	96		+3/-0	
No. of cells & connections	pcs		60 in series	
Cell type		6"Mono-crystalline si	licon with PERL technology (Hyunda	í cell, Made In Korea)
Module efficiency	%6	17.1	17.4	17.7
Temperature coefficient of Pmpp	%/K	-0.42	-0.42	-0.42
Temperature coefficient of Voc	96/K	-0.30	-0.30	-0.30
Temperature coefficient of Isc	%/K	0.047	0.047	0.047

Module Diagram



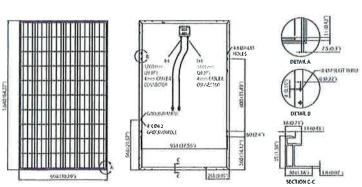
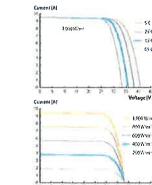
| I-V Curves |

Installation Safety Guide

- · Only qualified personnel should install or perform maintenance.
- · Be aware of dangerous high DC voltage.
- Do not damage or scratch the rear surface of the module.
- · Do not handle or install modules when they are wet.



46°C ± 2 -40 - B5°C DC 1,000 V (IEC) DC 600 V (UL) 15 A

Little Sed Date: December 2015



Hyundai Bldg., 75, Yulgok-10, Jongno-gu, Seoul 03058, Korea Tel: +82-2-746 4671, 7635, 8556 Fax: +82-2-746-7675



RC ENGINEERING, LLC COA # 28345 2381 CREST RIDGE COURT SANFORD, FL 32771 TEL: 407-474-9181ERMOCRATES E CASTILLO - FL PE 52590

REVISIONS							
DESCRIPTION	DATE	REV					
		-					
		-					
		-					
		1					

PROJECT DEVELOPER





32809 CHARLINE KENNEDY RESIDENCE 2624 HOMEWOOD BELLE ISLE, FL 3

SHEET NAME

DATA SHEET

SHEET SIZE

ANSI B 11" X 17"

SHEET NUMBER

DS-03















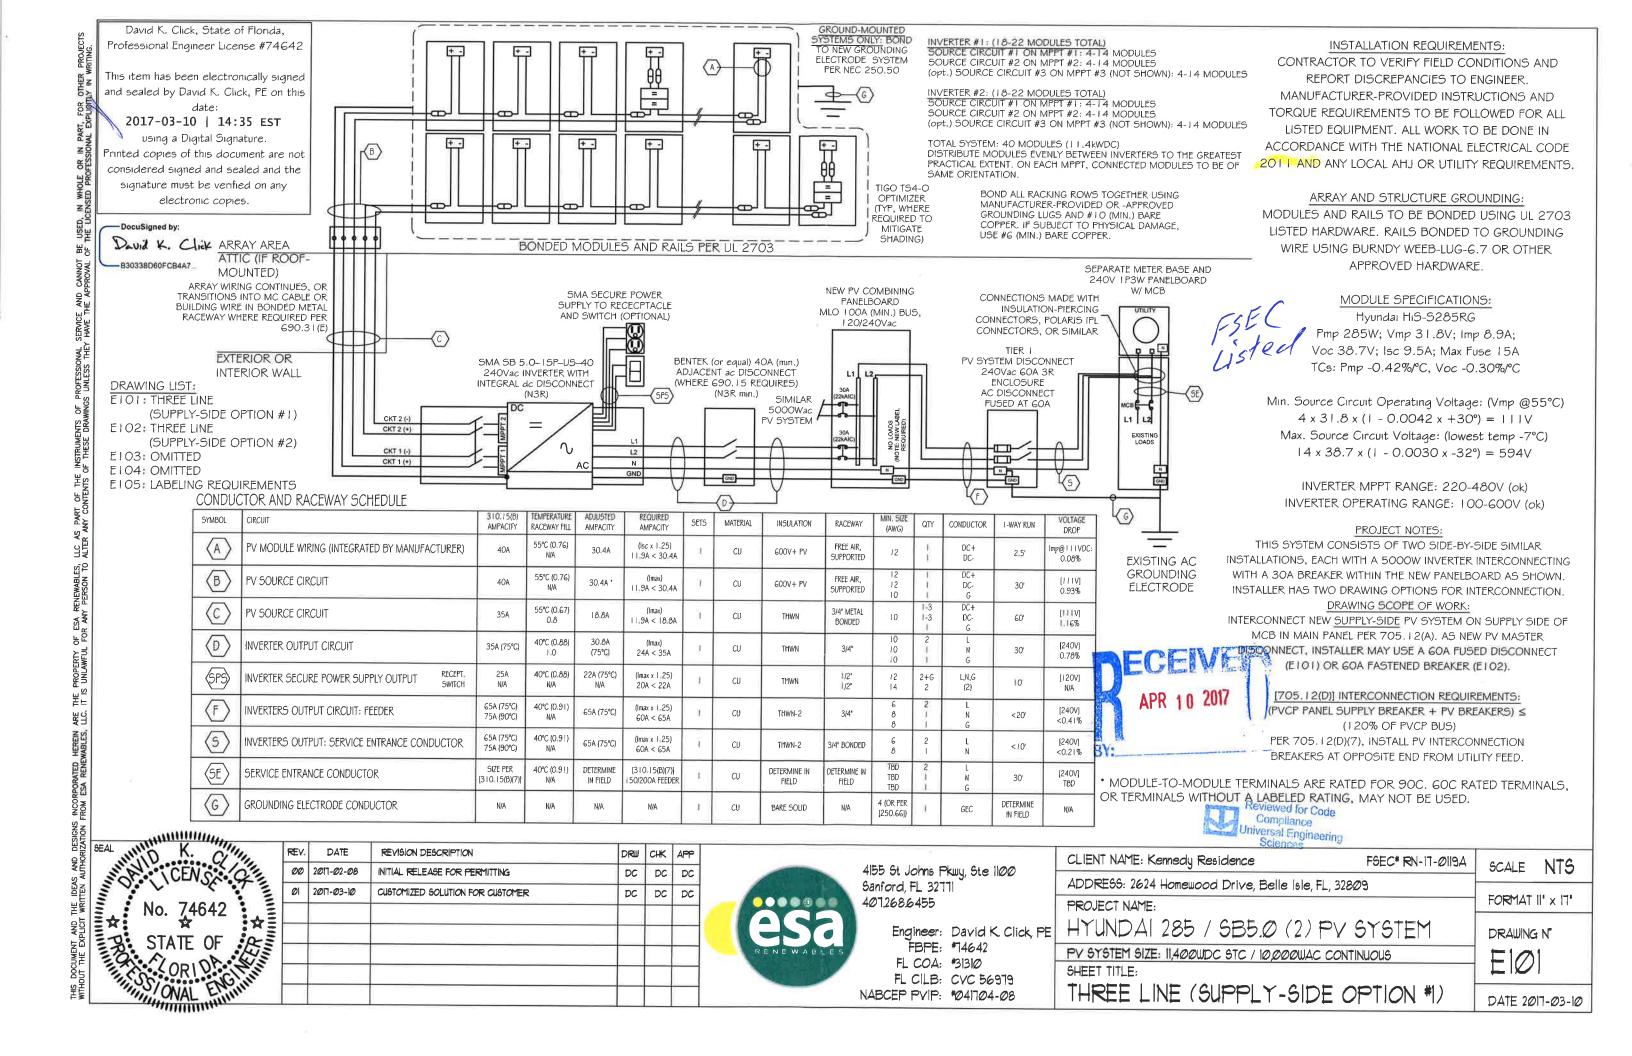

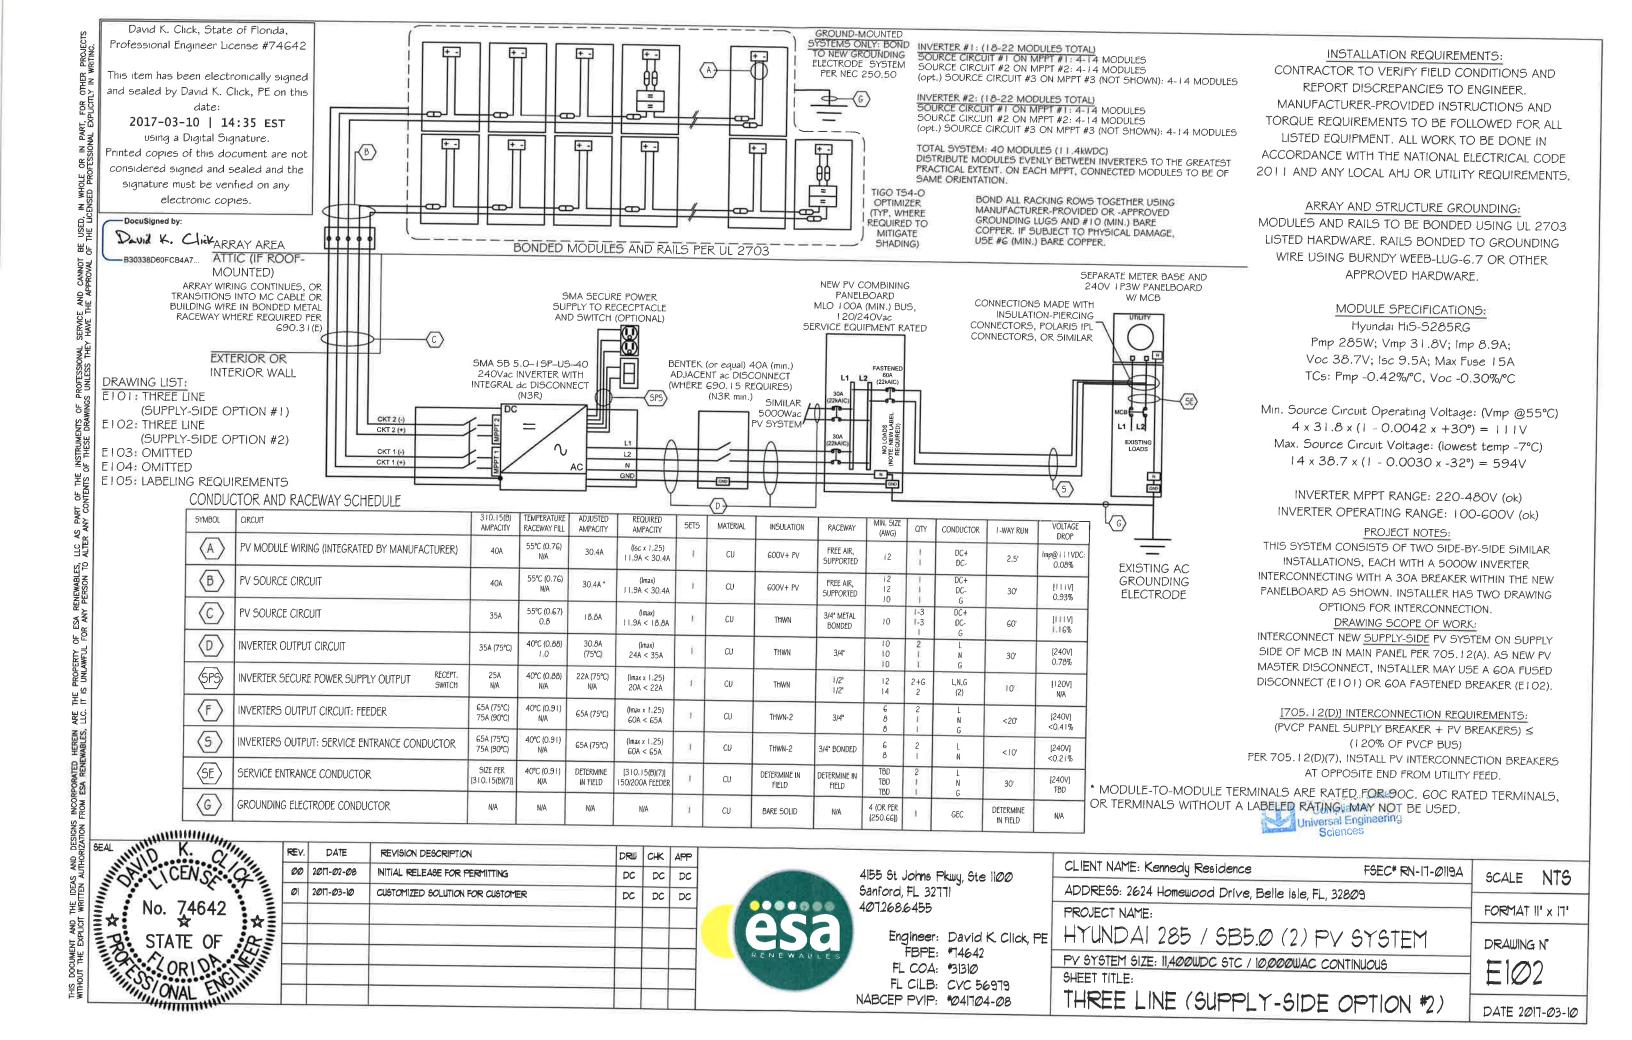

ALL LABELS TO COMPLY WITH [FFPC], [2011 NEC 110.21] OR [2014 NEC 110.21(B)] AS APPLICABLE; LABELS SHALL BE OF SUFFICIENT DURABILITY TO WITHSTAND THE ENVIRONMENT INVOLVED.

AT EACH DC JUNCTION BOX: [690.35(F)] LABEL

WARNING: ELECTRIC SHOCK HAZARD THE DC CONDUCTORS OF THIS PHOTOVOLTAIC SYSTEM ARE UNGROUNDED AND MAY BE ENERGIZED

EXPOSED INDOOR/OUTDOOR DC WIRING AT (MAX.) 10' INTERVALS:

[690.31(E)] AND FFPC 11.12.2.1.3.21 PHOTOVOLTAIC POWER SOURCE

AT DC DISCONNECT:

[690.14(C)(2)] DC DISCONNECT LABEL SOLAR DC DISCONNECT

[690.53] PV POWER SOURCE DC RATING**

RATED CURRENT AT MAXIMUM POWER: 8.9A | 8.9A | 8.9A RATED VOLTAGE AT MAXIMUM POWER: 318V | 318V | 318V MAXIMUM SYSTEM VOLTAGE: 424V | 424V | 424V MAXIMUM SYSTEM CURRENT: 11.9A | 11.9A | 11.9A

** CONTRACTOR TO MODIFY TO MEET FIELD CONDITIONS

ARE THE PROPERTY OF ESA RENEWABLES, LLC AS PART OF THE INSTRUMENTS OF PROFESSIONAL LLC. IT IS UNLAWFUL FOR ANY PERSON TO ALTER ANY CONTENTS OF THESE DRAWINGS UNLESS THEY

HEREIN WABLES.

INCORPORATED ROM ESA RENE

THE IDEAS AND DESIGNS WRITTEN AUTHORIZATION

THIS DOCUMENT AND WITHOUT THE EXPLICIT

David K. Click

MINIMULE.

-B30338D60FCB4A7

AT AC DISCONNECTS:

[690.15]

SOLAR AC DISCONNECT

AT PV INTERCONNECTION POINTS:

[690.54] PV POWER SOURCE AC RATING (QTY: 2)

RATED CURRENT: 24A RATED VOLTAGE: 240V

[690.54] PV POWER SOURCE AC RATING (QTY: 1)

RATED CURRENT: 48A RATED VOLTAGE: 240V

AT UTILITY SERVICE DISCONNECT: [PER FFPC | 1.12.2.1.1]

WARNING: PHOTOVOLTAIC POWER SOURCE INCLUDE PV INSTALLER INFORMATION SIGNAGE PER FFPC 11.12.2.1.5

AT NEW PV COMBINING PANELBOARD:

SOLAR PV COMBINING PANELBOARD ONLY. NO LOAD CIRCUIT BREAKERS MAY BE ADDED.

David K. Click, State of Florida. Professional Engineer License #74642

This item has been electronically signed and sealed by David K. Click, PE on this

2017-03-10 | 14:35 EST

using a Digital Signature.

Printed copies of this document are not considered signed and sealed and the signature must be verified on any electronic copies.

AT MAIN PV SYSTEM AC DISCONNECTS.

AND AT UTILITY SERVICE DISCONNECT:

[705.10] DISCONNECT LOCATIONS

SYSTEM SPECIFIC. COULD INCLUDE EITHER CLEAR TEXT DESCRIPTION OR A MAP OF SITE DESCRIBING LOCATIONS OF ALL POWER DISCONNECTS: 1) UTILITY SERVICE DISCONNECT. 2) PV SYSTEM DISCONNECT

DISCONNECTS SHALL BE LABELED:

ELECTRICAL DISCONNECT #1 OF 2: UTILITY ELECTRICAL DISCONNECT #2 OF 2: SOLAR

LABEL "PHOTOVOLTAIC DISCONNECT" PER FFPC 11.12.2.1.1

[705.12(D)(7)]: IN A PANELBOARD, WHEN THE SUM OF ITS UTILITY SUPPLY BREAKER AND ITS PV INVERTER BREAKER(S) EXCEED ITS RATING, BREAKERS SHALL BE LOCATED AT OPPOSITE ENDS OF THE BUS WITH THIS LABEL NEAR THE PV INVERTER BREAKER(S) (EQUIVALENT WORDING ACCEPTABLE):

WARNING

INVERTER OUTPUT CONNECTION DO NOT RELOCATE THIS OVERCURRENT DEVICE

COLOR CODING:

DC+: RED OR ORANGE DC-: BLACK OR BLUE GROUND: GREEN OR BARE

AC LI BLACK; L2: RED; N: WHITE OR GREY

DRAWING LIST: Reviewed for Coo

Sciences

EIOI: THREE LINE (SUPPLY-SIDE OPTION #1) Universal Engineer of O2: THREE LINE (SUPPLY-SIDE OPTION #2)

> E103: OMITTED E104: OMITTED

E105: LABELING REQUIREMENTS

SEAL III	K. C''	REV.	DATE	REVISION DESCRIPTION	DRW	СНК	APP
JI'R	CENS	00	2017-02-08	INITIAL RELEASE FOR PERMITTING	DC	DC	DC
0	No. 74040	01	2017-03-10	CUSTOMIZED SOLUTION FOR CUSTOMER	DC	DC	DC
	No. 74642						
0	STATE OF						
10	SIATE OF THE						
11/2	SCORIO CONTE						
"	ONAL ENTINE						

4155 St Johns Pkwy, Ste 1100 Sanford, FL 32771 407.268.6455

> Engineer: David K Click PE FBPE: #74642

FL COA: *31310 FL CILB: CVC 56979

NABCEP PVIP: *041704-08

_					
	CLIENT NAME: Kennedy Residence	FSEC* RN-17-0119A	SCALE	NTS	
	ADDRESS: 2624 Homewood Drive, Belle Isle, FL, 328	309		1110	
	PROJECT NAME:		FORMAT	11' x 17'	
1	HYUNDAI 285 / SB5.0 (2) PV	SYSTEM	DRAWING N°		
	PV SYSTEM SIZE: 11,400WDC STC / 10,000WAC CON	TINUOUS	EIØ	5	
1	SHEET TITLE:		9		
	LABELING REQUIREMENTS		DATE 2Ø	17-03-10	



STATE OF FLORIDA DEPARTMENT OF BUSINESS AND PROFESSIONAL REGULATION

CONSTRUCTION INDUSTRY LICENSING BOARD 2601 BLAIR STONE ROAD TALLAHASSEE FL 32399-0783

(850) 487-1395

CLICK, DAVID KARLSSON ESA RENEWABLES LLC 4155 ST JOHNS PKWY STE 1100 SANFORD FL 32771

Congratulations! With this license you become one of the nearly one million Floridians licensed by the Department of Business and Professional Regulation. Our professionals and businesses range from architects to yacht brokers, from boxers to barbeque restaurants, and they keep Florida's economy strong.

Every day we work to improve the way we do business in order to serve you better. For information about our services, please log onto www.myfloridalicense.com. There you can find more information about our divisions and the regulations that impact you, subscribe to department newsletters and learn more about the Department's initiatives.

Our mission at the Department is: License Efficiently, Regulate Fairly. We constantly strive to serve you better so that you can serve your customers. Thank you for doing business in Florida, and congratulations on your new license!



CERTIFIED SOLAR CONTRACTOR CLICK, DAVID KARLSSON ESA RENEWABLES LLC

IS CERTIFIED under the provisions of Ch. 489 FS. Expiration date: AUG 31, 2018 L1608280004269

DETACH HERE

RICK SCOTT, GOVERNOR

KEN LAWSON, SECRETARY

STATE OF FLORIDA

DEPARTMENT OF BUSINESS AND PROFESSIONAL REGULATION CONSTRUCTION INDUSTRY LICENSING BOARD

LICENSE NUMBER

CVC56979

The SOLAR CONTRACTOR Named below IS CERTIFIED Under the provisions of Chapter 489 FS. Expiration date: AUG 31, 2018

> CLICK, DAVID KARLSSON ESA RENEWABLES LLC 4155 ST JOHNS PKWY STE 1100 SANFORD FL 32771





ISSUED: 08/28/2016

DISPLAY AS REQUIRED BY LAW

SEQ# L1608280004269



CERTIFICATE OF LIABILITY INSURANCE

DATE (MM/DD/YYYY) 3/31/2017

THIS CERTIFICATE IS ISSUED AS A MATTER OF INFORMATION ONLY AND CONFERS NO RIGHTS UPON THE CERTIFICATE HOLDER. THIS CERTIFICATE DOES NOT AFFIRMATIVELY OR NEGATIVELY AMEND, EXTEND OR ALTER THE COVERAGE AFFORDED BY THE POLICIES BELOW. THIS CERTIFICATE OF INSURANCE DOES NOT CONSTITUTE A CONTRACT BETWEEN THE ISSUING INSURER(S), AUTHORIZED REPRESENTATIVE OR PRODUCER, AND THE CERTIFICATE HOLDER.

IMPORTANT: If the certificate holder is an ADDITIONAL INSURED, the policy(ies) must be endorsed. If SUBROGATION IS WAIVED, subject to the terms and conditions of the policy, certain policies may require an endorsement. A statement on this certificate does not confer rights to the certificate holder in lieu of such endorsement(s).

PRODUCER Sihle Insurance Group, Inc. 1021 Douglas Ave. Altamonte Springs FL 32714				CONTACT Marcy Reinoehl PHONE (A/C, No, Ext): 407-257-1857 FAX (A/C, No): 407-389-8428 E-MAIL ADDRESS: mreinoehl@sihle.com					
J 3					INSURER(S) AFFORDING COVERAGE				NAIC#
					INSURER A : Security National Insurance Co.				19879
INSU		ESAI	RENE	E-01	INSURE	RB:			
	Renewables, LLC 5 St. John's Parkway, Suite 1100				INSURE	RC:			
	ford FL 32771				INSURE	RD:			
					INSURE	RE:			
		- 17			INSURE	RF:			
CO	/ERAGES CER	TIFIC	CATE	NUMBER: 435589760				REVISION NUMBER:	
IN CE	IIS IS TO CERTIFY THAT THE POLICIES DICATED. NOTWITHSTANDING ANY RE- ERTIFICATE MAY BE ISSUED OR MAY ICLUSIONS AND CONDITIONS OF SUCH	EQUIF PERT POLI	REMEI AIN, CIES.	NT, TERM OR CONDITION THE INSURANCE AFFORDI	OF ANY	CONTRACT THE POLICIES REDUCED BY	OR OTHER DESCRIBED PAID CLAIMS.	OCUMENT WITH RESPECT HEREIN IS SUBJECT TO A	TO WHICH THIS
INSR LTR	TYPE OF INSURANCE	INSD	SUBR WVD	POLICY NUMBER		POLICY EFF (MM/DD/YYYY)	POLICY EXP (MM/DD/YYYY)	LIMITS	
A	X COMMERCIAL GENERAL LIABILITY			SES134541600		12/1/2016	12/1/2017		,000,000
	CLAIMS-MADE X OCCUR							DAMAGE TO RENTED PREMISES (Ea occurrence) \$1	00,000
								MED EXP (Any one person) \$5	5,000
								PERSONAL & ADV INJURY \$1	,000,000
	GEN'L AGGREGATE LIMIT APPLIES PER:							GENERAL AGGREGATE \$2	2,000,000
	X POLICY PRO- JECT LOC								2,000,000
_	OTHER:							COMBINED SINGLE LIMIT &	
	AUTOMOBILE LIABILITY							(Ea accident)	
	ANY AUTO ALL OWNED SCHEDULED							BODILY INJURY (Per person) \$	
	ALL OWNED SCHEDULED AUTOS NON-OWNED							BODILY INJURY (Per accident) \$ PROPERTY DAMAGE	
	HIRED AUTOS AUTOS				9			(Per accident)	
_	UMBRELLA LIAB OCCUP							\$	
2	- FYOTOS LLAD							EACH OCCURRENCE \$	
	DED RETENTION \$							AGGREGATE \$	
	WORKERS COMPENSATION							PER OTH- STATUTE ER	
	AND EMPLOYERS' LIABILITY ANY PROPRIETOR/PARTNER/EXECUTIVE						-	STATUTE ER E.L. EACH ACCIDENT \$	
	OFFICER/MEMBER EXCLUDED? (Mandatory in NH)	N/A						E.L. DISEASE - EA EMPLOYEE \$	
	If yes, describe under DESCRIPTION OF OPERATIONS below						Ì	E.L. DISEASE - POLICY LIMIT \$	
								THE PIOC OF TOLIO PENNIT OF	
Х									
DESC	RIPTION OF OPERATIONS / LOCATIONS / VEHIC	LES (A	CORD	101, Additional Remarks Schedu	le, may be	attached if more	e space is requir	ed)	
5.5%5.5						ia .			
CEF	RTIFICATE HOLDER				CANC	ELLATION			
City of Belle Isle 1600 Nela Avenue Belle Isle FL 32809					THE	EXPIRATION	DATE THE	ESCRIBED POLICIES BE CANG REOF, NOTICE WILL BE Y PROVISIONS.	
						RIZED REPRESEN		. 10	
	1				TY	farcelle	e Ke	noed	
	1					@ 108	38-2014 ACC	ORD CORPORATION AIL	rights reserved

ACORD 25 (2014/01)

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CERTIFICATE OF LIABILITY INSURANCE

DATE(MM/DD/YYYY) 03/31/2017

THIS CERTIFICATE IS ISSUED AS A MATTER OF INFORMATION ONLY AND CONFERS NO RIGHTS UPON THE CERTIFICATE HOLDER. THIS CERTIFICATE DOES NOT AFFIRMATIVELY OR NEGATIVELY AMEND, EXTEND OR ALTER THE COVERAGE AFFORDED BY THE POLICIES BELOW. THIS CERTIFICATE OF INSURANCE DOES NOT CONSTITUTE A CONTRACT BETWEEN THE ISSUING INSURER(S), AUTHORIZED REPRESENTATIVE OR PRODUCER, AND THE CERTIFICATE HOLDER.

IMPORTANT: If the certificate holder is an ADDITIONAL INSURED, the policy(ies) must be endorsed. If SUBROGATION IS WAIVED, subject to the terms and conditions of the policy, certain policies may require an endorsement. A statement on this certificate does not confer rights to the certificate holder in lieu of such endorsement(s).

DUCER					CONTACT Paychex Insurance Agency Inc					
PAYCHEX INSURANCE AGENCY, INC. 150 SAWGRASS DRIVE								FAX (A/C, No):	585-389-7426	
ROCHESTER, NY 14620					E-MAIL ADDRESS: Certs@paychex.com					
					INSURER(S) AFFORDING COVERAGE				NAIC#	
URED					INSURER A: NEW HAMPSHIRE INSURANCE COMPANY				23841	
Paychex Business Solutions LLC ESA Renewables LLC 911 PANORAMA TRAIL SOUTH				INSURER B:						
				INSURER C:						
ROCHESTER, NY 14625-0397					INSURER D:					
					INSURER E:					
					INSURER F:					
VERAGES CERTIFICATE NUMBER:					REVISION NUMBER:					
EXCLUSIONS AND CONDITIONS OF TYPE OF INSURANCE	UED OR MAY PERTAIN, THE INSURANCE AFFORD TIONS OF SUCH POLICIES. LIMITS SHOWN MAY H NCE ADDL SUBR POLICY NUMBER INSURANCE WYD			AVE BEEN	BEEN REDUCED BY PAID CLAIMS. POLICY EFF POLICY EXP LIMITS (MM/DD/YYYY) (MM/DD/YYYY)					
GENERAL LIABILITY	III.	,,,,			(MM/DD/TTTT)	(MM/DD/TTT)	EACH OCCURRENCE	s		
COMMERCIAL GENERAL LIABILITY							DAMAGE TO RENTED PREMISES (Ea occurrence	-		
CLAIMS-MADEOCCUR							MED EXP (Any one person	-1		
							PERSONAL & ADV INJUR	Y \$		
EN'L AGGREGATE LIMIT APPLIES PER:							GENERAL AGGREGATE	\$		
POLICY PROJECT LOC							PRODUCTS - COMP/OP A	AGG \$		
AUTOMOBILE LIABILITY	-							\$		
ANY AUTO							COMBINED SINGLE LIMIT (Ea accident)	\$		
ALL OWNED SCHEDULED AUTOS							BODILY INJURY (Per person)	\$		
HIRED AUTOS NON-OWNED AUTOS							BODILY INJURY (Per accident)	\$		
							PROPERTY DAMAGE (Per accident)	\$		

CRIPTION OF OPERATIONS / LOCATIONS / VEHICLES (Attach ACORD 101, Additional Remarks Schedule, if more space is required) Worker's Compensation coverage is provided to only those employees leased to, but not subcontractors of the named insured. Client Inception Date with PBS is 01/23/2017

015722020

UMBRELLA LIAB

WORKERS COMPENSATION AND

OFFICER/MEMBER EXCLUDED?

ANY PROPRIETOR/PARTNER/EXECUTIVE

EXCESS LIAB

EMPLOYERS' LIABILITY

DED

(Mandatory in NH)

If yes, describe unde DESCRIPTION OF OPERAT OCCUR

Y/N N

N/A

RETENTION \$

City of Belle Isle 1600 Nela Ave Belle Isle, FL 32809

CANCELLATION

SHOULD ANY OF THE ABOVE DESCRIBED POLICIES BE CANCELLED BEFORE THE EXPIRATION PROVISIONS, BUT FAILURE TO MAIL SUCH NOTICE SHALL IMPOSE NO OBLIGATION OR LIABILITY OF ANY KIND UPON THE COMPANY, ITS AGENTS OR REPRESENTATIVES.

EACH OCCURRENCE

X WC STATU-TORY LIMITS

E.L. EACH ACCIDENT

E.L. DISEASE - EA EMPLOYEE

E.L. DISEASE - POLICY LIMIT

AGGREGATE

s

\$

\$

\$

1,000,000.00

1,000,000.00

\$ 1,000,000.00

AUTHORIZED REPRESENTATIVE

06/01/2016

06/01/2017

Supar

ORD 25 (2010/05)

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SEMINOLE COUNTY BUSINESS TAX RECEIPT

RAY VALDES, SEMINOLE COUNTY TAX COLLECTOR

PO Box 630 Sanford, FL 32772-0630 Telephone: 407-665-1000 www.seminoletax.org

VALID THROUGH 09/30/17

ESA RENEWABLES LLC 4155 ST JOHNS PKWY #1100 SANFORD, FL 32771

Account #: 173442

LINDSAY HEROLD (OFFICER)

NOT REGULATED

wanter or memorphanity, not does to exempt the tampeyor from any outer required

**SANFORD CITY LICENSE REQUIRED **

Receipt #: OLHS2016081700204

Amount Paid: \$ 25.00

Date Paid: 08/17/2016